
# ORFORDVILLE SALT SHED



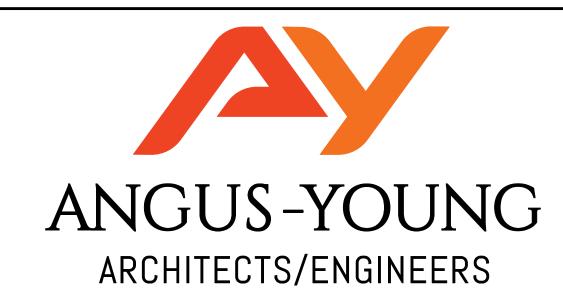

Janesville | Madison

ORFORDVILLE SALT SHED

ROCK COUNTY PUBLIC WORKS

734 WEST BELOIT STREET ORFORDVILLE, WI

## SHEET INDEX:

- G001 COVER SHEET
- C100 EXISTING SITE & DEMOLITION PLAN
- C101 SITE LAYOUT PLAN C300 OVERALL SITE GRADING PLAN
- C301 SITE GRADING PLAN WEST C302 SITE GRADING PLAN - EAST
- C303 SITE EROSION CONTROL PLAN
- C401 SITE UTILITY PLAN C601 LANDSCAPE PLAN
- C801 SITE DETAILS C802 EROSION CONTROL NOTES AND DETAILS
- A101 SALT SHED PLAN AND DETAILS A401 BUILDING ELEVATIONS
- A601 BUILDING SECTION VIEW A602 BUILDING SECTION VIEW
- S101 STRUCTURAL FOUNDATION PLANS AND NOTES S102 WALL REINFORCEMENT PLAN
- S801 STRUCTURAL DETAILS
- E101 SALT SHED ELECTRICAL PLAN AND ONE LINE DIAGRAM E102 SALT SHED PHOTOMETRIC CALCULATIONS

## REGULATORY DATA:

AY PROJECT NUMBER: 74660

PROJECT ADDRESS 734 WEST BELOIT STREET ORFORDVILLE, WI

**BUILDING CODE** 

WISCONSIN ENROLLED 2015 IBC

USE AND OCCUPANCY CLASSIFICATION

S-2 - LOW HAZARD STORAGE

GENERAL BUILDING HEIGHT AND AREA

AREA = 6,624 S.F. STORIES = 1 MAXIMUM HEIGHT = 39'-9"

TYPE OF CONSTRUCTION

5B - WOOD FRAMED

PROJECT LOCATION ———

## LOCATION MAP:



	ISSUANCES / REVISIONS			
NO:	DESCRIPTION:	DATE:		
BD	BID/CONSTRUCTION	02/01/2023		

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## **PROJECT TEAM**

ROCK COUNTY

51 S. MAIN STREET

PHONE: Owner Phone

JANESVILLE, WI 53545 CONTACT: BRENT SUTHERLAND EMAIL: brent.sutherland@co.rock.wi.us ARCHITECT:

ANGUS-YOUNG ASSOCIATES, INC. 555 S. River St. Janesville, WI 53548

CONTACT: BRAD WERGINZ EMAIL: b.werginz@angusyoung.com PHONE: (608)756-2326

STRUCTURAL ENGINEER:

ANGUS-YOUNG ASSOCIATES, INC. 555 S. River St. Janesville, WI 53548

CONTACT: ZACHARY GOSWICK, PE EMAIL: z.goswick@angusyoung.com PHONE: (608)756-2326

CIVIL ENGINEER:

ANGUS-YOUNG ASSOCIATES, INC. 555 S. River St. Janesville, WI 53548

CONTACT: SUZANNE SCHLEEPER, PE EMAIL: s.schleeper@angusyoung.com PHONE: (608)756-2326

**ELECTRICAL ENGINEER:** ANGUS-YOUNG ASSOCIATES, INC.

Janesville, WI 53548 CONTACT: MITCHELL ABENDROTH EMAIL: m.abendroth@angusyoung.com

555 S. River St.

PHONE: (608)756-2326

LANDSCAPE ARCHITECT:

ANGUS-YOUNG ASSOCIATES, INC. 555 S. River St. Janesville, WI 53548


CONTACT: KATIE UDELL, PLA EMAIL: k.udell@angusyoung.com PHONE: (608)756-2326


24 | 20 | 16 | 12 | 08 | 04 | 23 | 19 | 15 | 11 | 07 | 03 | 22 | 18 | 14 | 10 | 06 | 02 21 | 17 | 13 | 09 | 05 | 01


> DETAILS IN THIS SET ARE PLACED ON THE SHEETS AND NUMBERED WITH RESPECT TO THE GRID ABOVE. CONSEQUENTLY, DETAILS ON A GIVEN SHEET MAY OR MAY NOT BE NUMBERED CONSECUTIVELY.

608.756.2326 www.angusyoung.com

**COVER SHEET** 

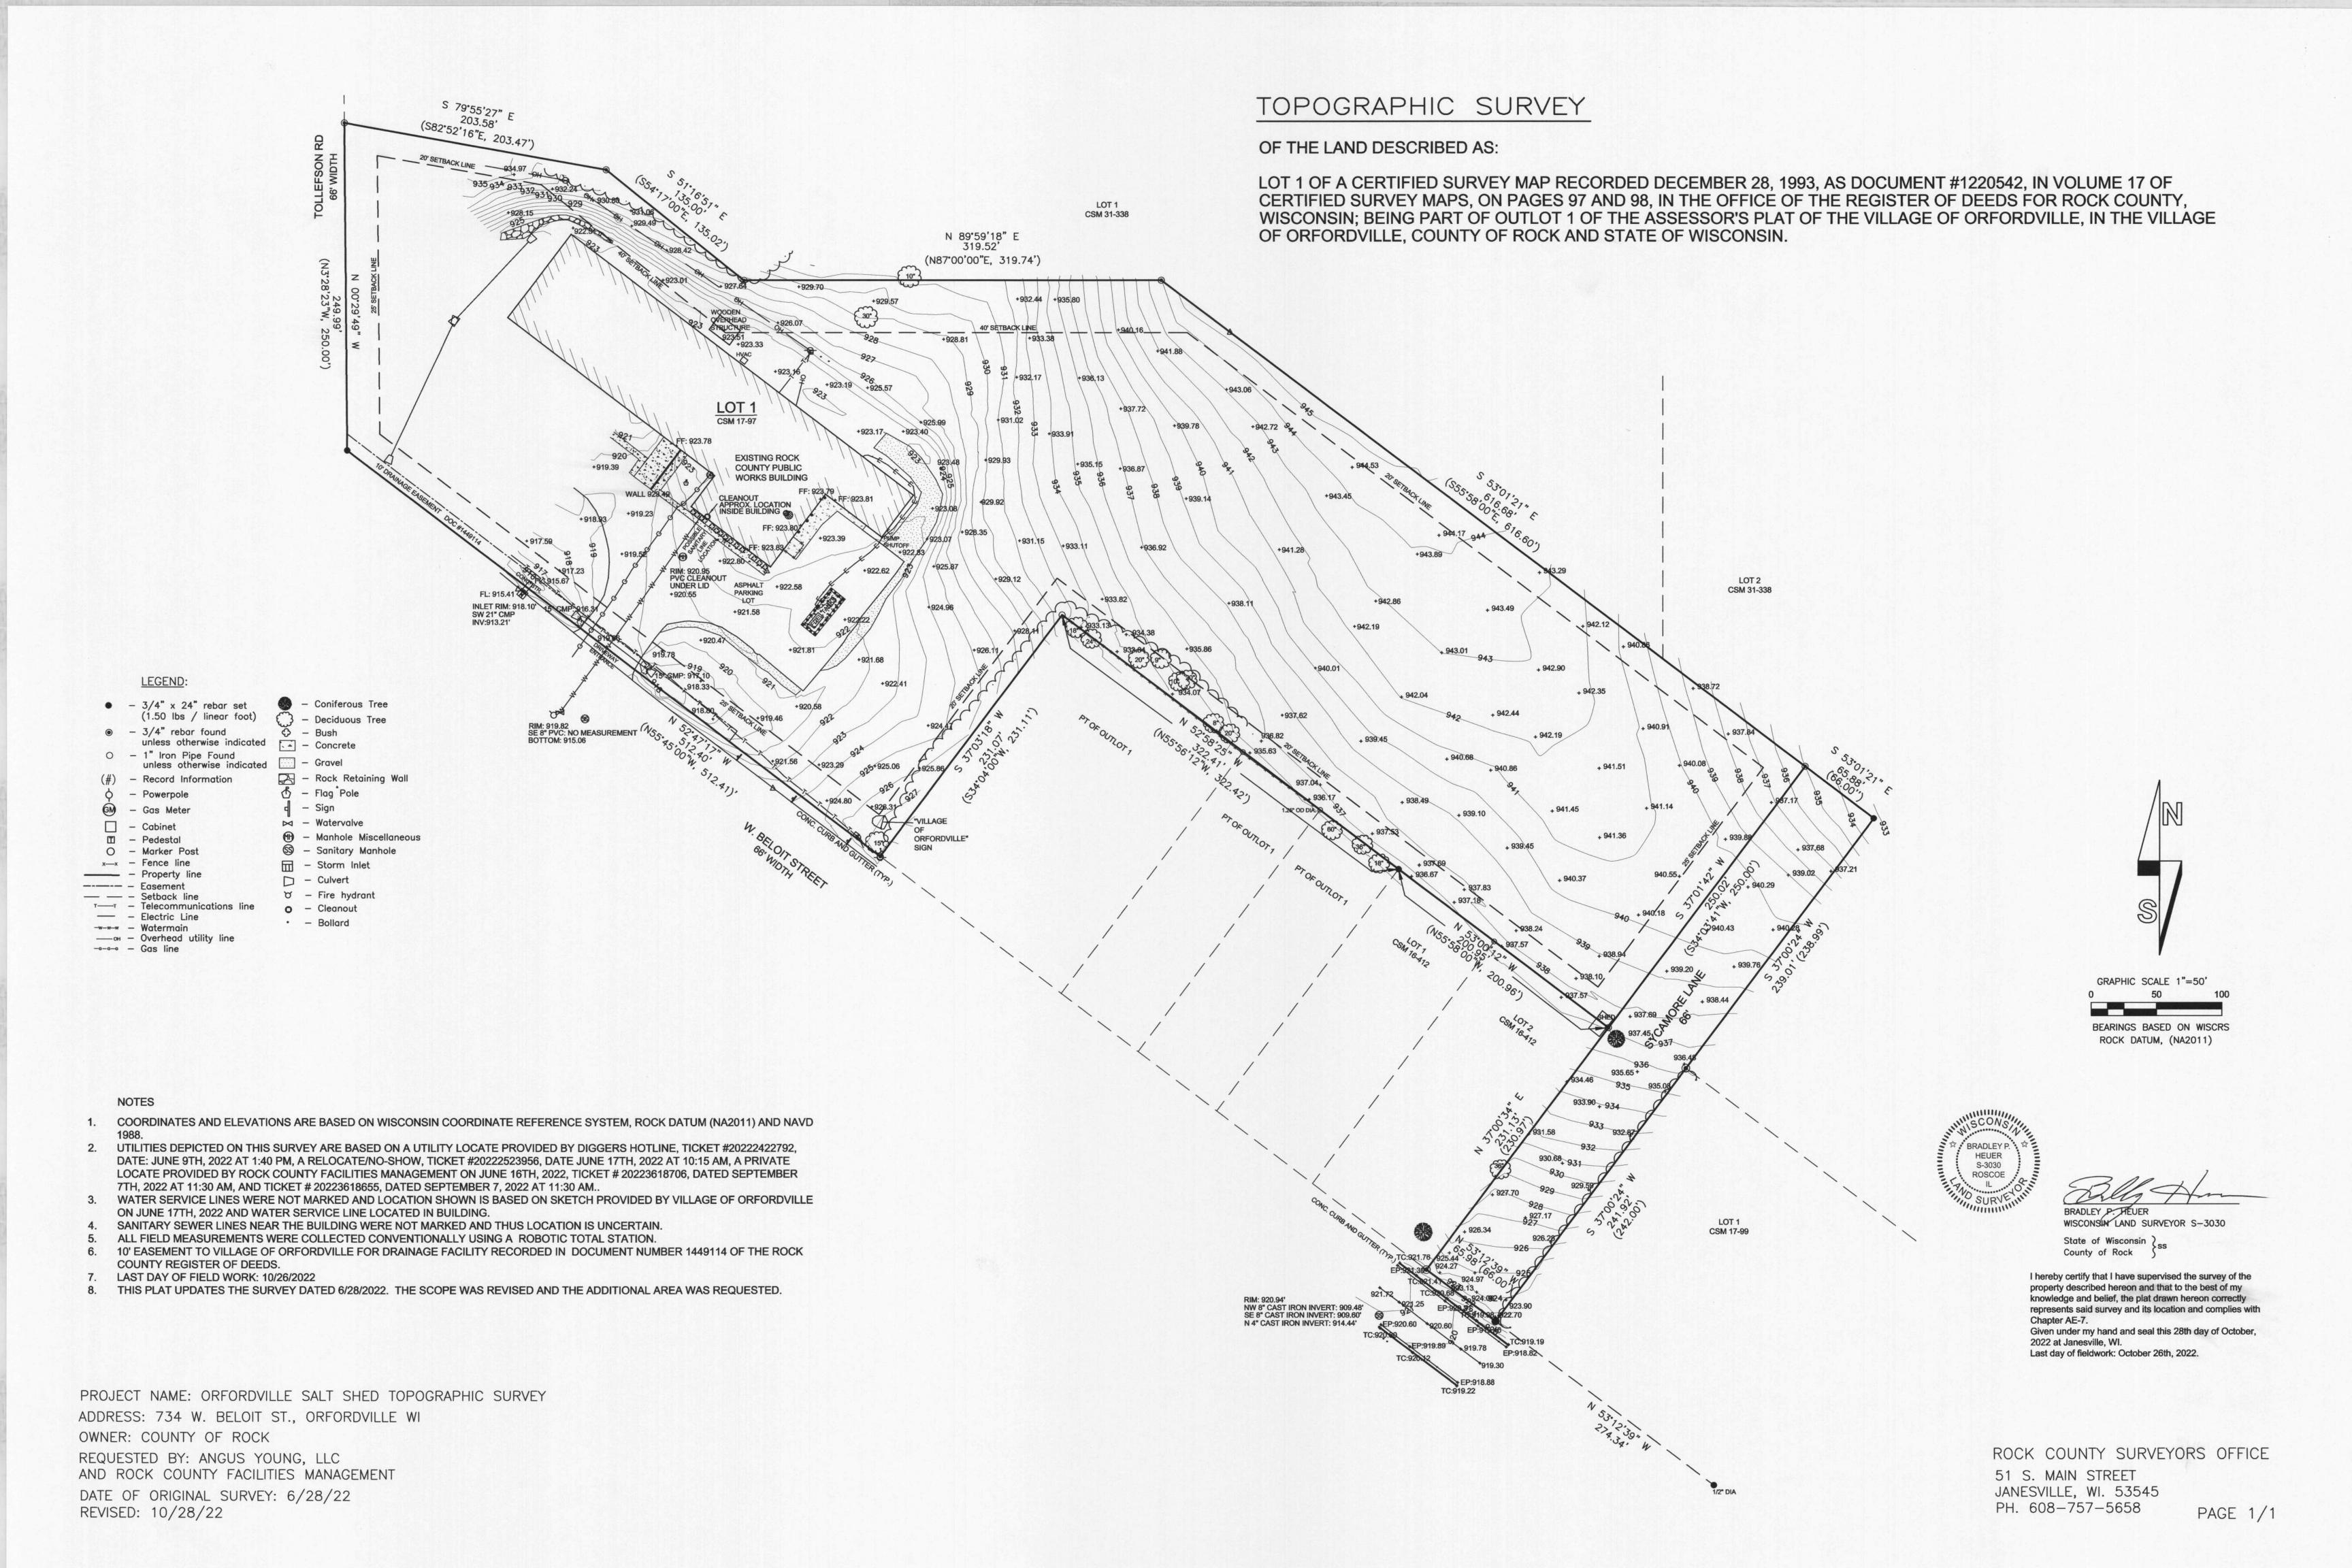

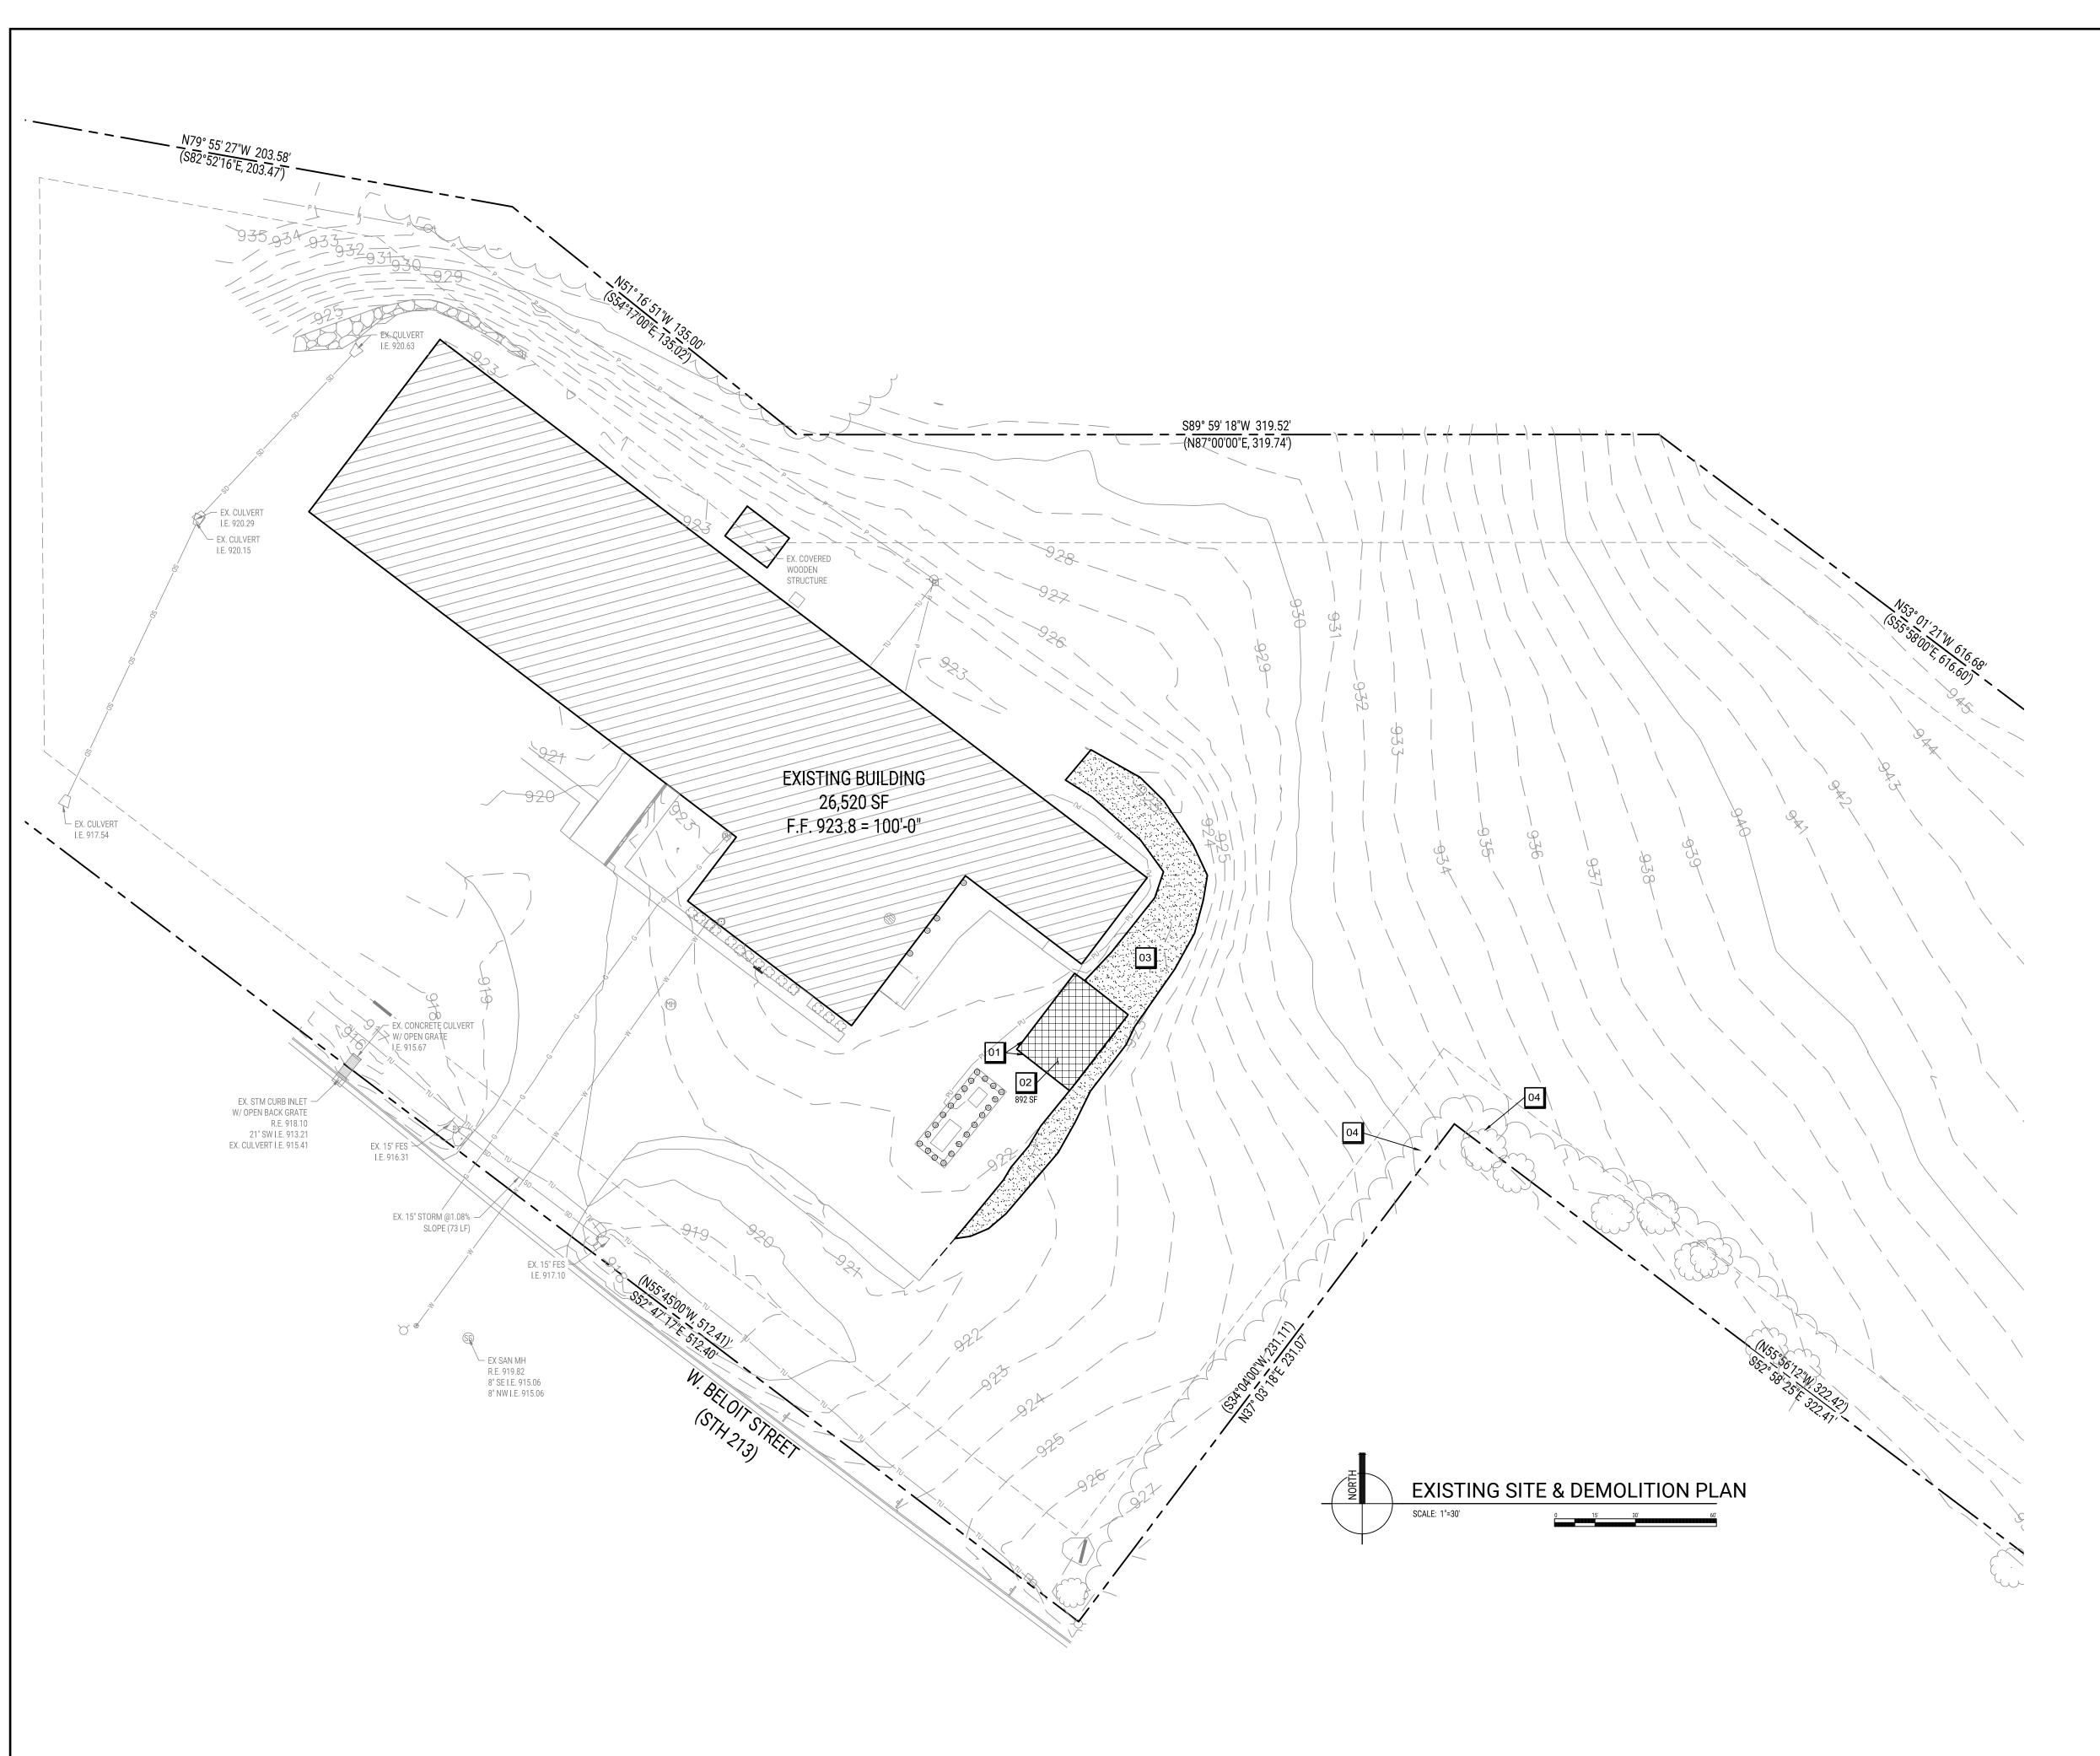

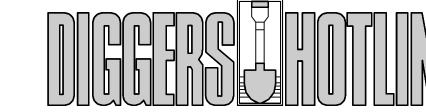

WISCONSIN STATUE 182.0175 (1974) REQUIRES A MINIMUM OF THREE (3) WORKING DAYS NOTICE PRIOR TO EXCAVATION.

#### SITE GENERAL NOTES

TRUE NORTH MAY VARY FROM PROJECT NORTH. CONSTRUCTION PRACTICES, MEANS AND METHODS, AND JOB SITE SAFETY, SHALL REMAIN

ORDINANCES AS THEY PERTAIN TO THIS PROJECT.

- THE SOLE RESPONSIBILITY OF THE CONTRACTOR. 3. ALL WORK SHALL BE PERFORMED IN COMPLIANCE WITH THE FEDERAL OCCUPATIONAL HEALTH AND SAFETY ADMINISTRATION (OSHA), AND ALL FEDERAL, STATE AND LOCAL CODES AND
- FIELD VERIFY ALL EXISTING AND PROPOSED UTILITIES, ELEVATIONS AND DIMENSIONS.
  COORDINATE WITH THE AUTHORITY HAVING JURISDICTION AND UTILITY COMPANIES AS
- NECESSARY.

  6. BUILDING SHALL BE ORIENTED PARALLEL AND PERPENDICULAR TO EXISTING BUILDING AND/OR PROPERTY LINE AS SHOWN ON DRAWING.

  7. ALL EXTERIOR CONCRETE SIDEWALKS AND YARD SLABS SHALL BE 4,000 PSI. ALL CONCRETE
- PAVEMENT SHALL BE 4,500 PSI UNLESS NOTED OTHERWISE.

  8. ALL DAMAGED ASPHALT ON STH 213 SHOULD BE PATCHED WITH A MINIMUM 10-FOOT LONG PATCH THAT EXTENDS TO THE CENTERLINE.

#### DEMOLITION NOTES

- 1. FOR EXISTING BUILDING TO BE REMOVED, REMOVE STRUCTURE, FOOTINGS AND ASSOCIATED WALK AND PAVEMENT. DISCONNECT EXISTING UTILITY SERVICE LINES PER CITY, COUNTY AND

- STATE SPECIFICATIONS.

  2. FOR EXISTING PAVEMENTS, CURBING, AND SITE AMENITIES, REMOVE ALL AT-GRADE AND BELOW GRADE SITE WORK PER OWNER.

  3. CONTRACTOR SHALL FIELD VERIFY ALL EXISTING SITE CONDITIONS PRIOR TO COMMENCING WORK AND COORDINATE WITH OWNER ANY ADDITIONAL ITEMS NOT SHOWN ON THE PLANS.

  4. CONTRACTOR SHALL CALL FOR UTILITY LOCATIONS PRIOR TO COMMENCING ALL WORK ON SITE.

  5. CONTRACTOR SHALL PROVIDE ALL NECESSARY EROSION CONTROL MEASURES PER LOCAL AND STATE REQUIREMENTS. ALL MEASURES SHALL BE INSTALLED PRIOR TO COMMENCING WORK ON THE SITE. SEE EROSION CONTROL PLAN FOR ADDITIONAL INFORMATION.

  6. CONTRACTOR SHALL ORTAIN ALL NECESSARY PERMITS FOR DEMOLITION AND CONSTRUCTION
- 6. CONTRACTOR SHALL OBTAIN ALL NECESSARY PERMITS FOR DEMOLITION AND CONSTRUCTION PRIOR TO COMMENCING ALL WORK ON THE SITE.
- CONTRACTOR SHALL PROTECT ALL TREES NOT MARKED FOR DEMOLITION. CONTRACTOR SHALL TRIM TREES AS NEEDED. CONTRACTOR SHALL OBTAIN OWNER APPROVAL IF AN EXISTING TREE NEEDS TO BE REPLACED IF IT SEEMS UNHEALTHY TO REMAIN OR IT ENCROACHES THE BUILDING.

#### KEYNOTES

- O1 SAWCUT LIIMITS. MATCH INTO EXISTING ALIGNMENT & GRADE.
- 02 SAWCUT AND REMOVE EXISTING PAVEMENT.
- REMOVE EXISTING GRAVEL FOR NEW BUILDING AND SITE CONSTRUCTION. CONTRACTOR TO RE-USE GRAVEL PER OWNER'S DIRECTION.
- CLEAR AND GRUB TREES AS NECESSARY TO ALLOW FOR FINAL GRADING. CONTRACTOR SHALL NOTIFY PROPERTY OWNER PRIOR TO ANY CLEARING AND GRUBBING ACTIVITIES.

DEMOLITION & REMO	VALS LEGEND
+++++++++++++++++++++++++++++++++++++++	CURB REMOVAL
	SIDEWALK REMOVAL
	PAVEMENT REMOVAL
XXX	EXISTING INTERMEDIATE CONTOUR
XXX	EXISTING INDEX CONTOUR
SD	STORM DRAIN
ssss	SANITARY SEWER
w	WATER
	GAS
P P P	ELECTRICAL POWER
PU	UNDERGROUND ELECTRICAL POWE
	UNDERGROUND FIBER OPTIC
тттт	TELEPHONE

NOTE: ALL SYMBOLS MAY NOT BE USED IN THIS SET.

EDGE OF TREES OR SHRUBS

UNDERGROUND TELEPHONE



**ROCK COUNTY** 

ORFORDVILLE SALT SHED

734 W. BELOIT STREET ORFORDVILLE, WI 53576



	ISSUANCES / REVISIONS	
0:	DESCRIPTION:	DATE:
01	VILLAGE SITE PLAN SUBMITTAL	09.23.2022
)2	VILLAGE SITE PLAN SUBMITTAL	01.13.2023
03	FOR BIDDING	02.01.2023

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PROJECT NUMBER


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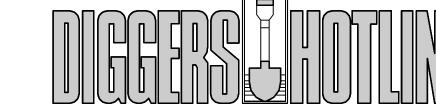
APPROVED BY BTW

REVIEWED BY

DRAWN BY

**EXISTING SITE & DEMOLITION** PLAN



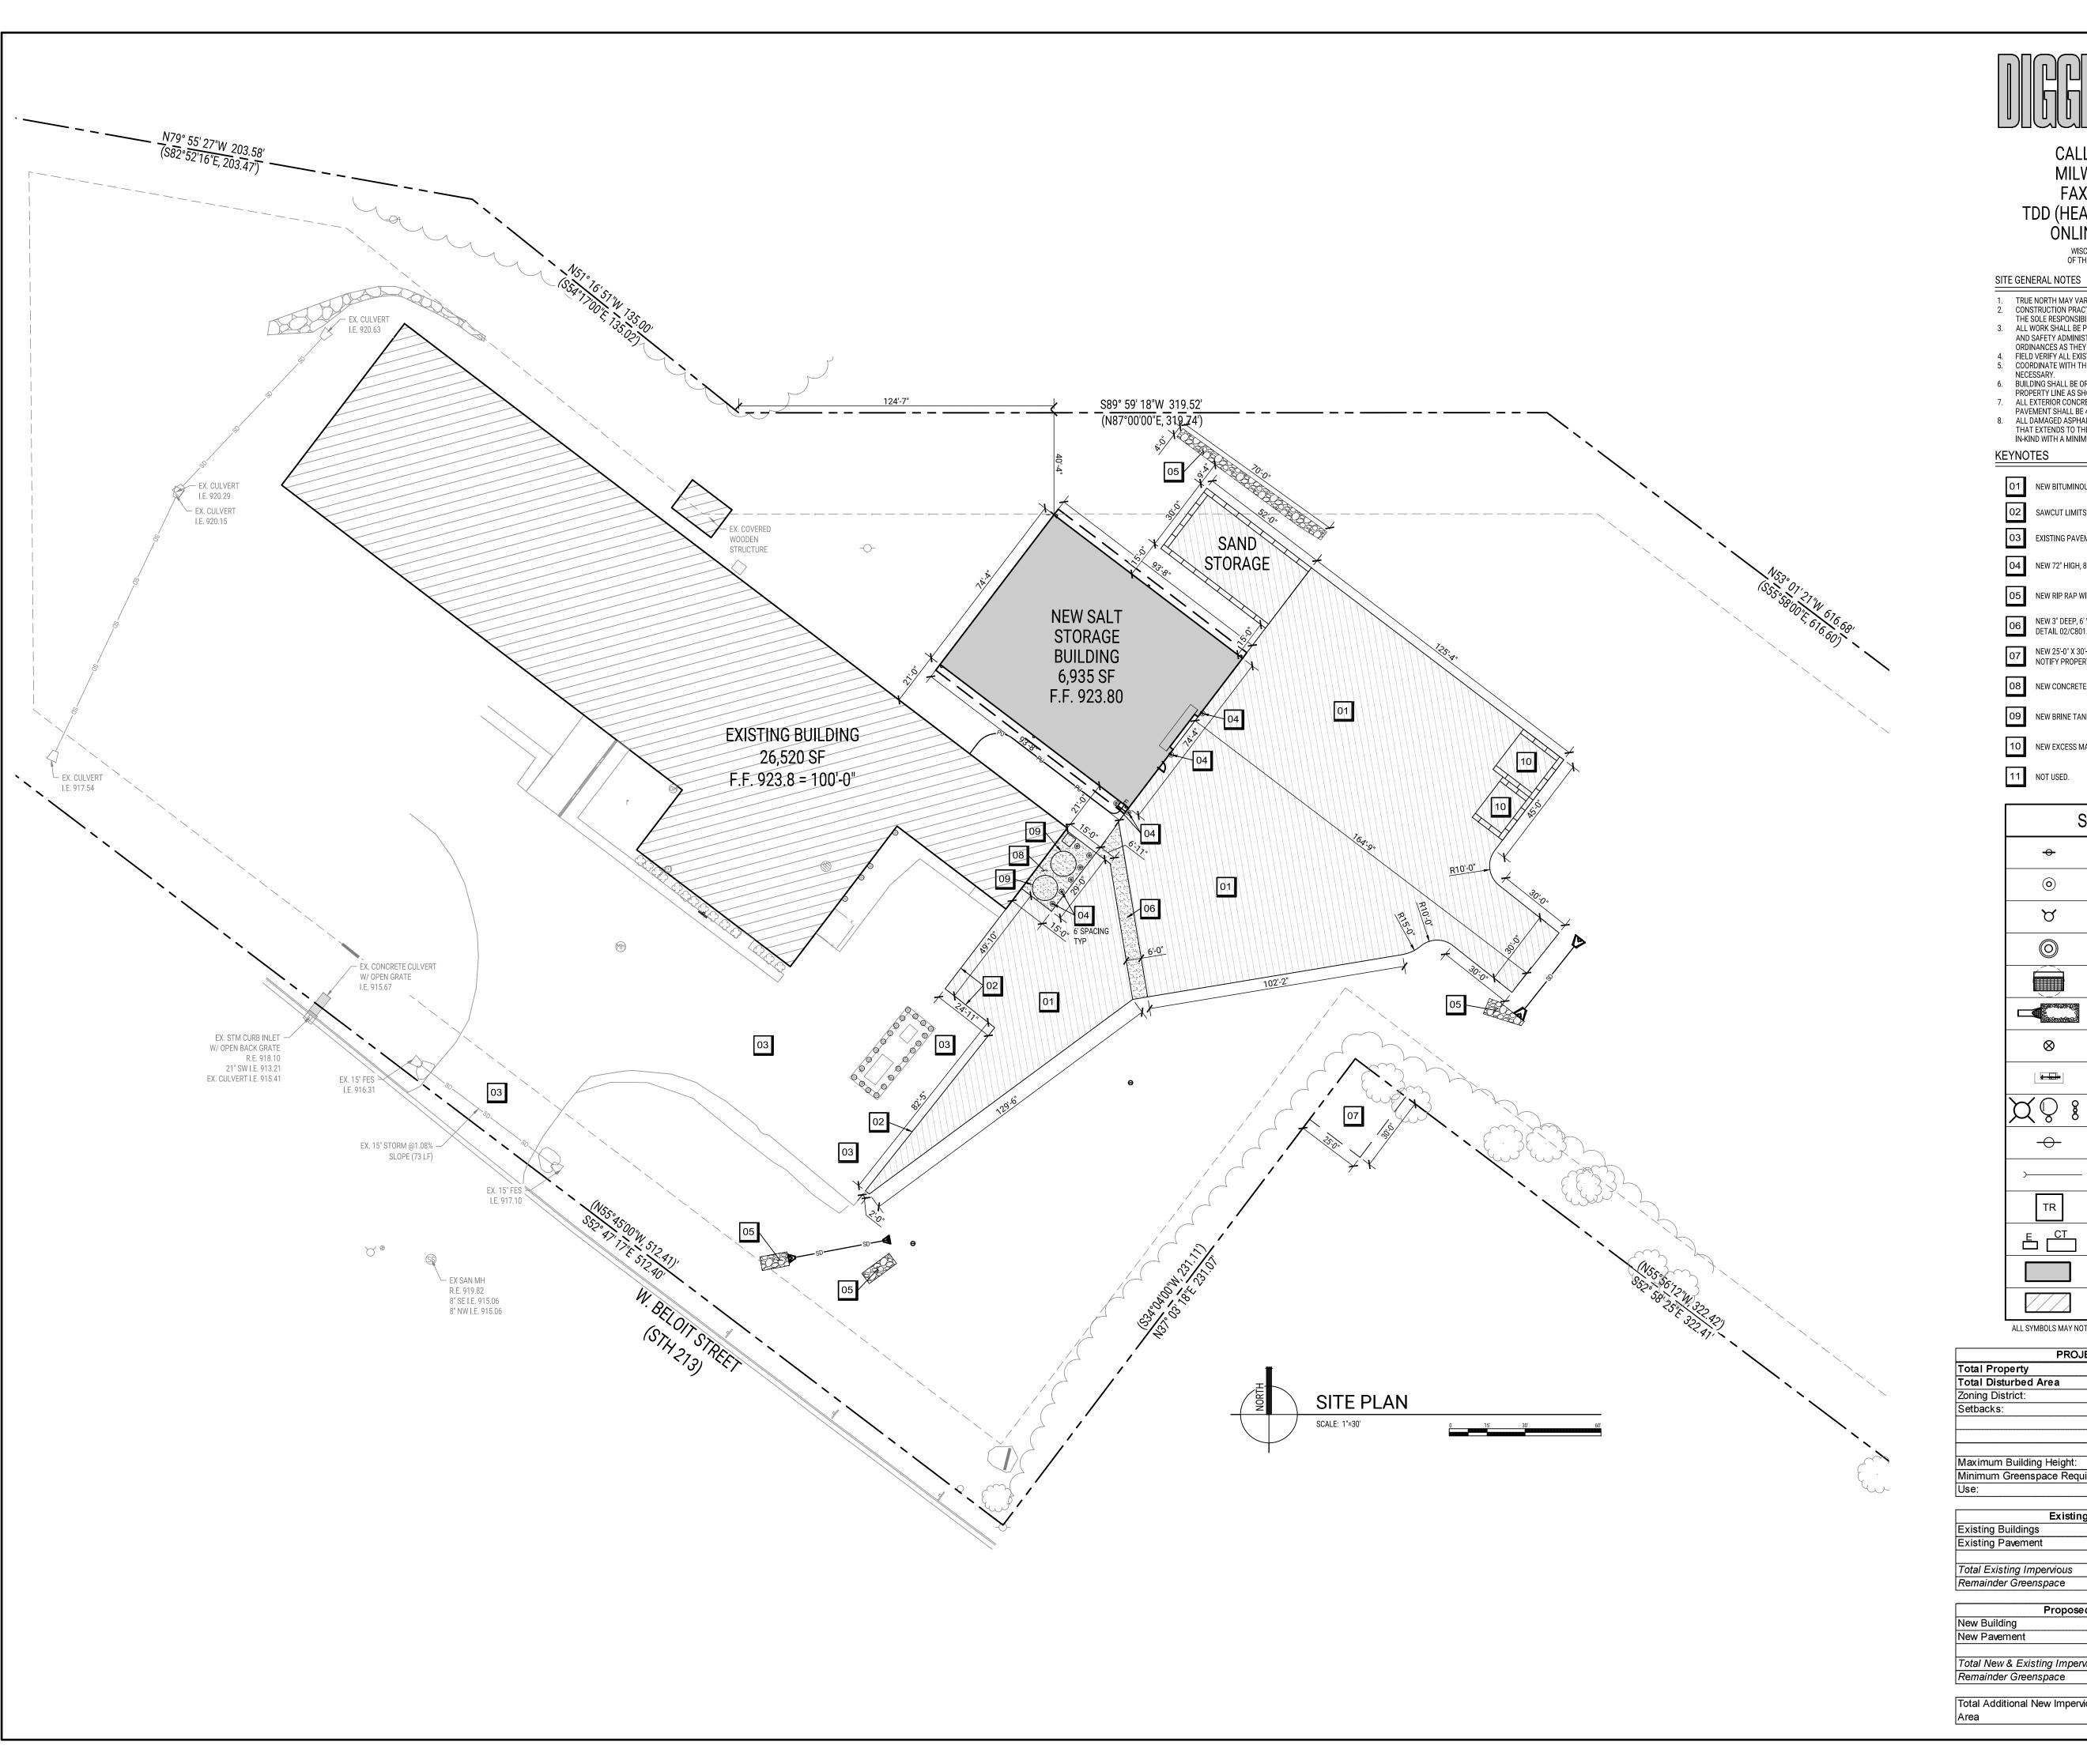

WISCONSIN STATUE 182.0175 (1974) REQUIRES A MINIMUM OF THREE (3) WORKING DAYS NOTICE PRIOR TO EXCAVATION.

- TRUE NORTH MAY VARY FROM PROJECT NORTH. CONSTRUCTION PRACTICES, MEANS AND METHODS, AND JOB SITE SAFETY, SHALL REMAIN
- 2. CONSTRUCTION PRACTICES, MEANS AND METHODS, AND JOB STIE SAFETY, SHALL REMAIN THE SOLE RESPONSIBILITY OF THE CONTRACTOR.

  3. ALL WORK SHALL BE PERFORMED IN COMPLIANCE WITH THE FEDERAL OCCUPATIONAL HEALTH AND SAFETY ADMINISTRATION (OSHA), AND ALL FEDERAL, STATE AND LOCAL CODES AND ORDINANCES AS THEY PERTAIN TO THIS PROJECT.

  4. FIELD VERIFY ALL EXISTING AND PROPOSED UTILITIES, ELEVATIONS AND DIMENSIONS.

  5. COORDINATE WITH THE AUTHORITY HAVING JURISDICTION AND UTILITY COMPANIES AS NECESSADY.

- NECESSARY.
   BUILDING SHALL BE ORIENTED PARALLEL AND PERPENDICULAR TO EXISTING BUILDING AND/OR PROPERTY LINE AS SHOWN ON DRAWING.
   ALL EXTERIOR CONCRETE SIDEWALKS AND YARD SLABS SHALL BE 4,000 PSI. ALL CONCRETE PAVEMENT SHALL BE 4,500 PSI UNLESS NOTED OTHERWISE.
   ALL DAMAGED ASPHALT ON STH 213 SHOULD BE PATCHED WITH A MINIMUM 10-FOOT PATCH THAT EXTENDS TO THE CENTERLINE OF THE ROADWAY. PAVEMENT SHALL BE REPLACED IN-KIND WITH A MINIMUM OF 4" ASPHALT PAVEMENT.
- O1 NEW BITUMINOUS PAVEMENT. SEE DETAIL 01/C801.
- O2 SAWCUT LIMITS. MATCH EXISTING PAVEMENT.
- 03 EXISTING PAVEMENT TO REMAIN.
- O4 NEW 72" HIGH, 8" DIA. CONCRETE FILLED PIPE BOLLARD. SEE DETAIL 03/C801.
- 05 NEW RIP RAP WITH GEOTEXTILE FABRIC, MEDIUM, 12" THICK.
- NEW 3" DEEP, 6' WIDE CONCRETE STRIP TO CHANNEL WATER ACROSS PAVEMENT. SEE DETAIL 02/C801.
- NEW 25'-0" X 30'-0" TEMPORARY CONSTRUCTION GRADING EASEMENT. CONTRACTOR SHALL NOTIFY PROPERTY OWNER PRIOR TO GRADING ACTIVITIES.
- 08 NEW CONCRETE PAVEMENT. SEE DETAIL 05/C801.
- 09 NEW BRINE TANK LOCATIONS.
- 10 NEW EXCESS MATERIAL BINS.

SI	TE SYMBOL LEGEND
<del>+</del>	SIGN
0	BOLLARD
В	FIRE HYDRANT
0	MANHOLE/CATCH BASIN/INLET
	CURB INLET
Secretary Action	NEW FLARED END SECTION WITH RIPRAP AND GUARD
8	WATER VALVE OR GAS VALVE
	GAS METER
XO 8	LIGHT POLE
-	UTILITY POLE
)———	GUY WIRE
TR	TRANSFORMER
E CT	ELECTRIC METER AND CT CABINET
	NEW STRUCTURE OR ADDITION
	EXISTING STRUCTURE

ALL SYMBOLS MAY NOT BE USED IN THIS SET.

Total Property	341	,946	sf	7.85 ac
Total Disturbed Area	166	,525	sf	3.82 ac
Zoning District:	I-1 Light	Indus	trial Di	strict
Setbacks:	25'-0''		Front Y	′ard
	20'-0''		Interior	Side
	25'-0''	,	Street	Side Yard
	40'-0''		Rear Y	ard
Maximum Building Height:	90'-0''			
Minimum Greenspace Requirement:		10%		34,195 s
Use:	Public L	Jtility I	Facility	,

Existing Buildings	136	Sf	0.00	ac	
Existing Pavement	3,393		0.08		
Total Existing Impervious	3,529	sf	0.08	ac	2%

Proposed Site =	Total Disturb	ed A	rea		
New Building	7,493	sf	0.17	ac	
New Pavement	16,183	sf	0.37	ac	
Total New & Existing Impervious	23,812	sf	0.55	ac	14%
Remainder Greenspace	142,713		3.28		86%

Total Additional New Impervious

20,283 sf



**ROCK COUNTY** 

ORFORDVILLE SALT SHED

734 W. BELOIT STREET

ORFORDVILLE, WI 53576



	1000/1110E0 / REVIOLONO	
):	DESCRIPTION:	DATE:
1	VILLAGE SITE PLAN SUBMITTAL	09.23.20
2	VILLAGE SITE PLAN SUBMITTAL	01.13.20
3	FOR BIDDING	02.01.20

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PROJECT NUMBER 74660

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APPROVED BY BTW

REVIEWED BY

DRAWN BY

SITE LAYOUT PLAN





ROCK COUNTY

ORFORDVILLE SALT SHED

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01	VILLAGE SITE PLAN SUBMITTAL	09.23.202
02	VILLAGE SITE PLAN SUBMITTAL	01.13.202
03	FOR BIDDING	02.01.202

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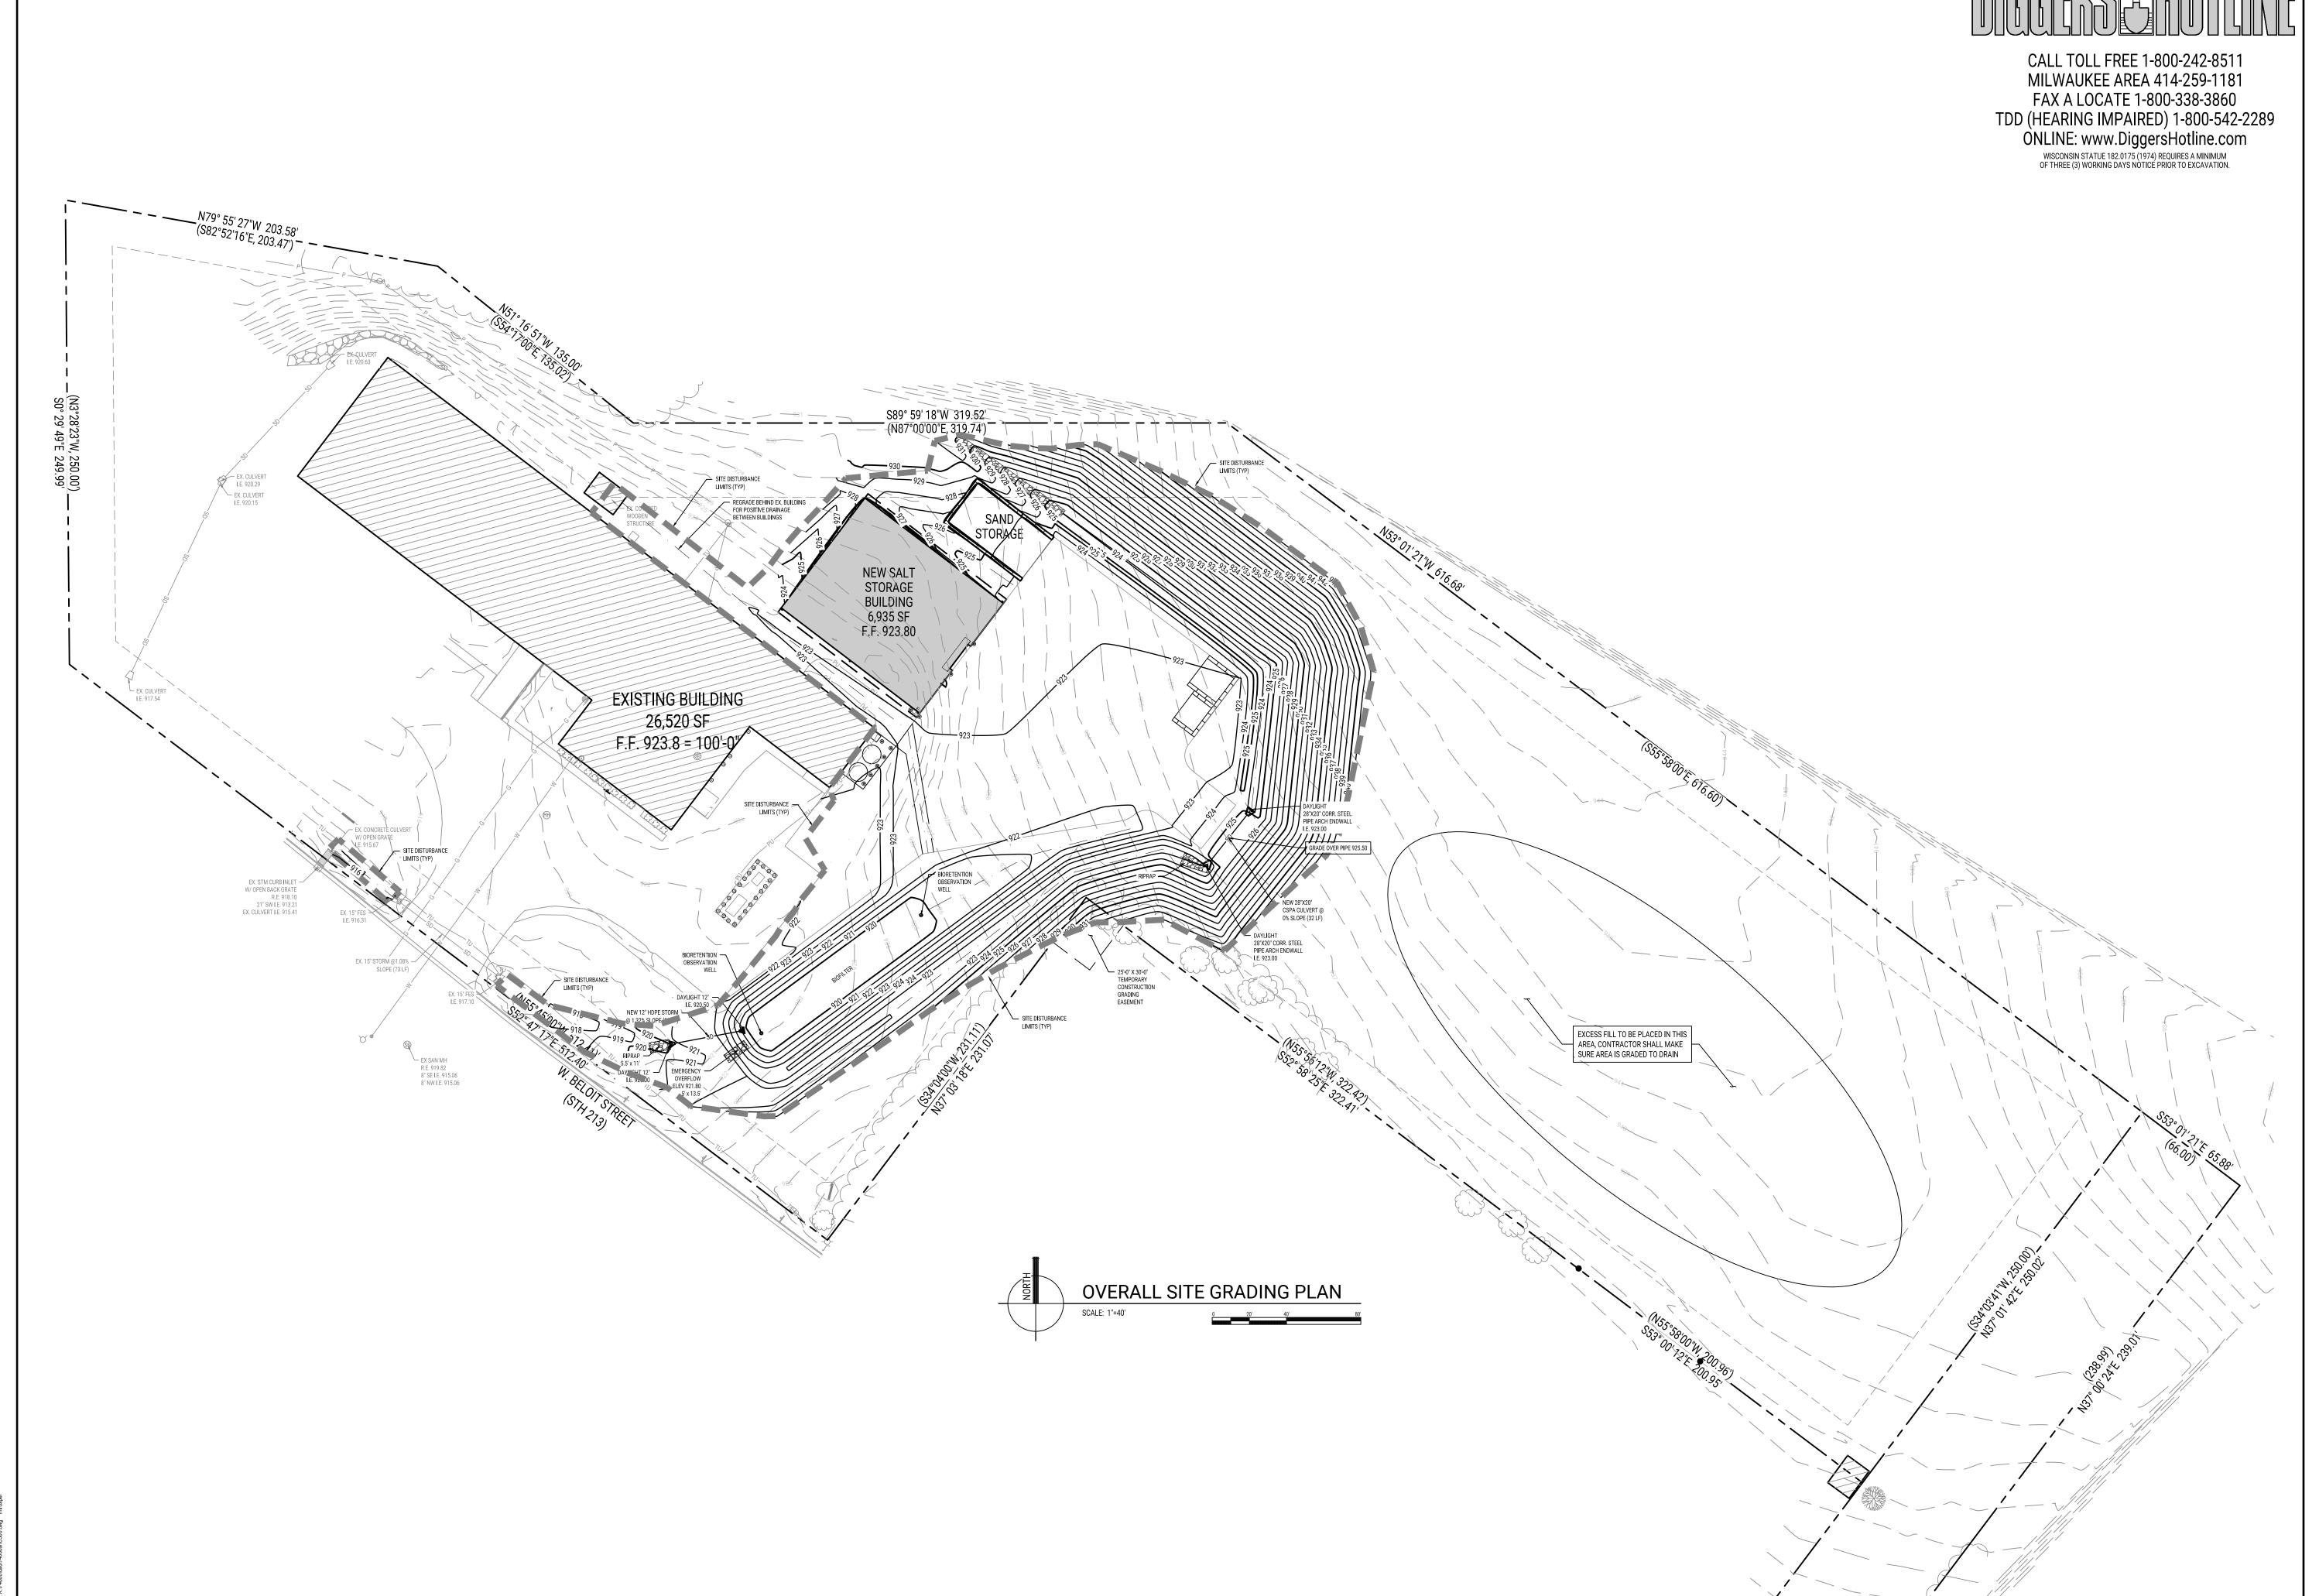
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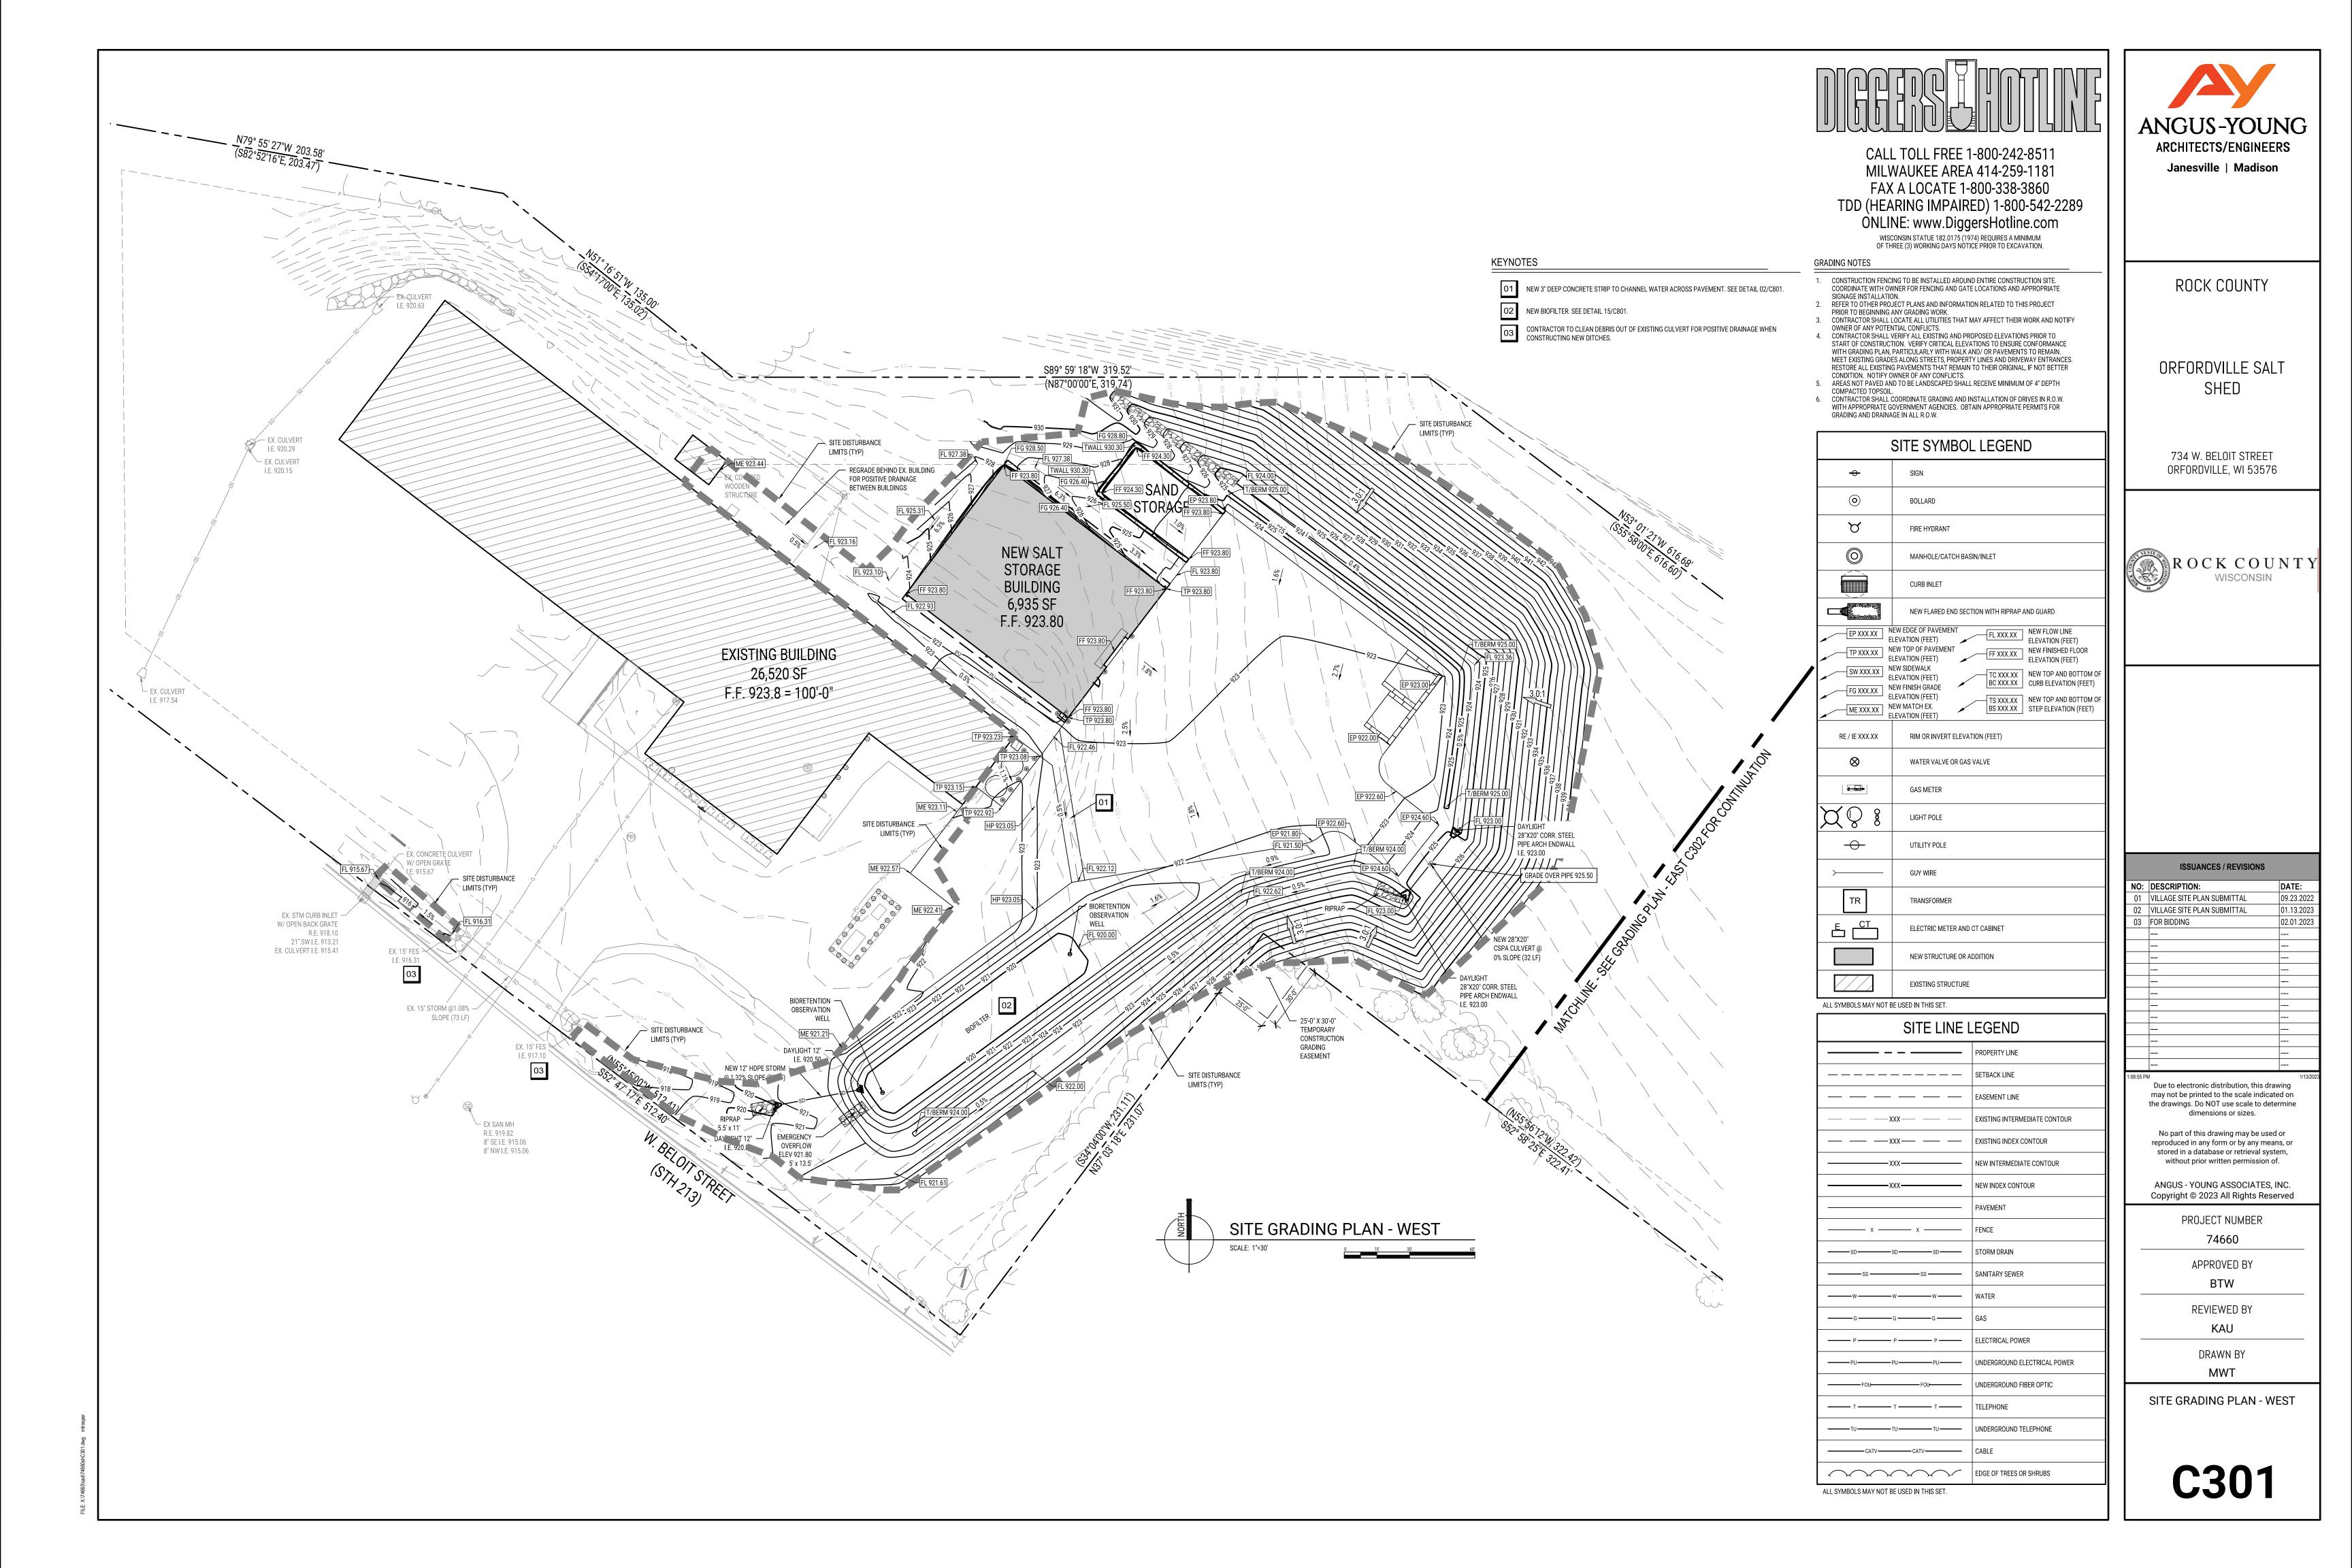
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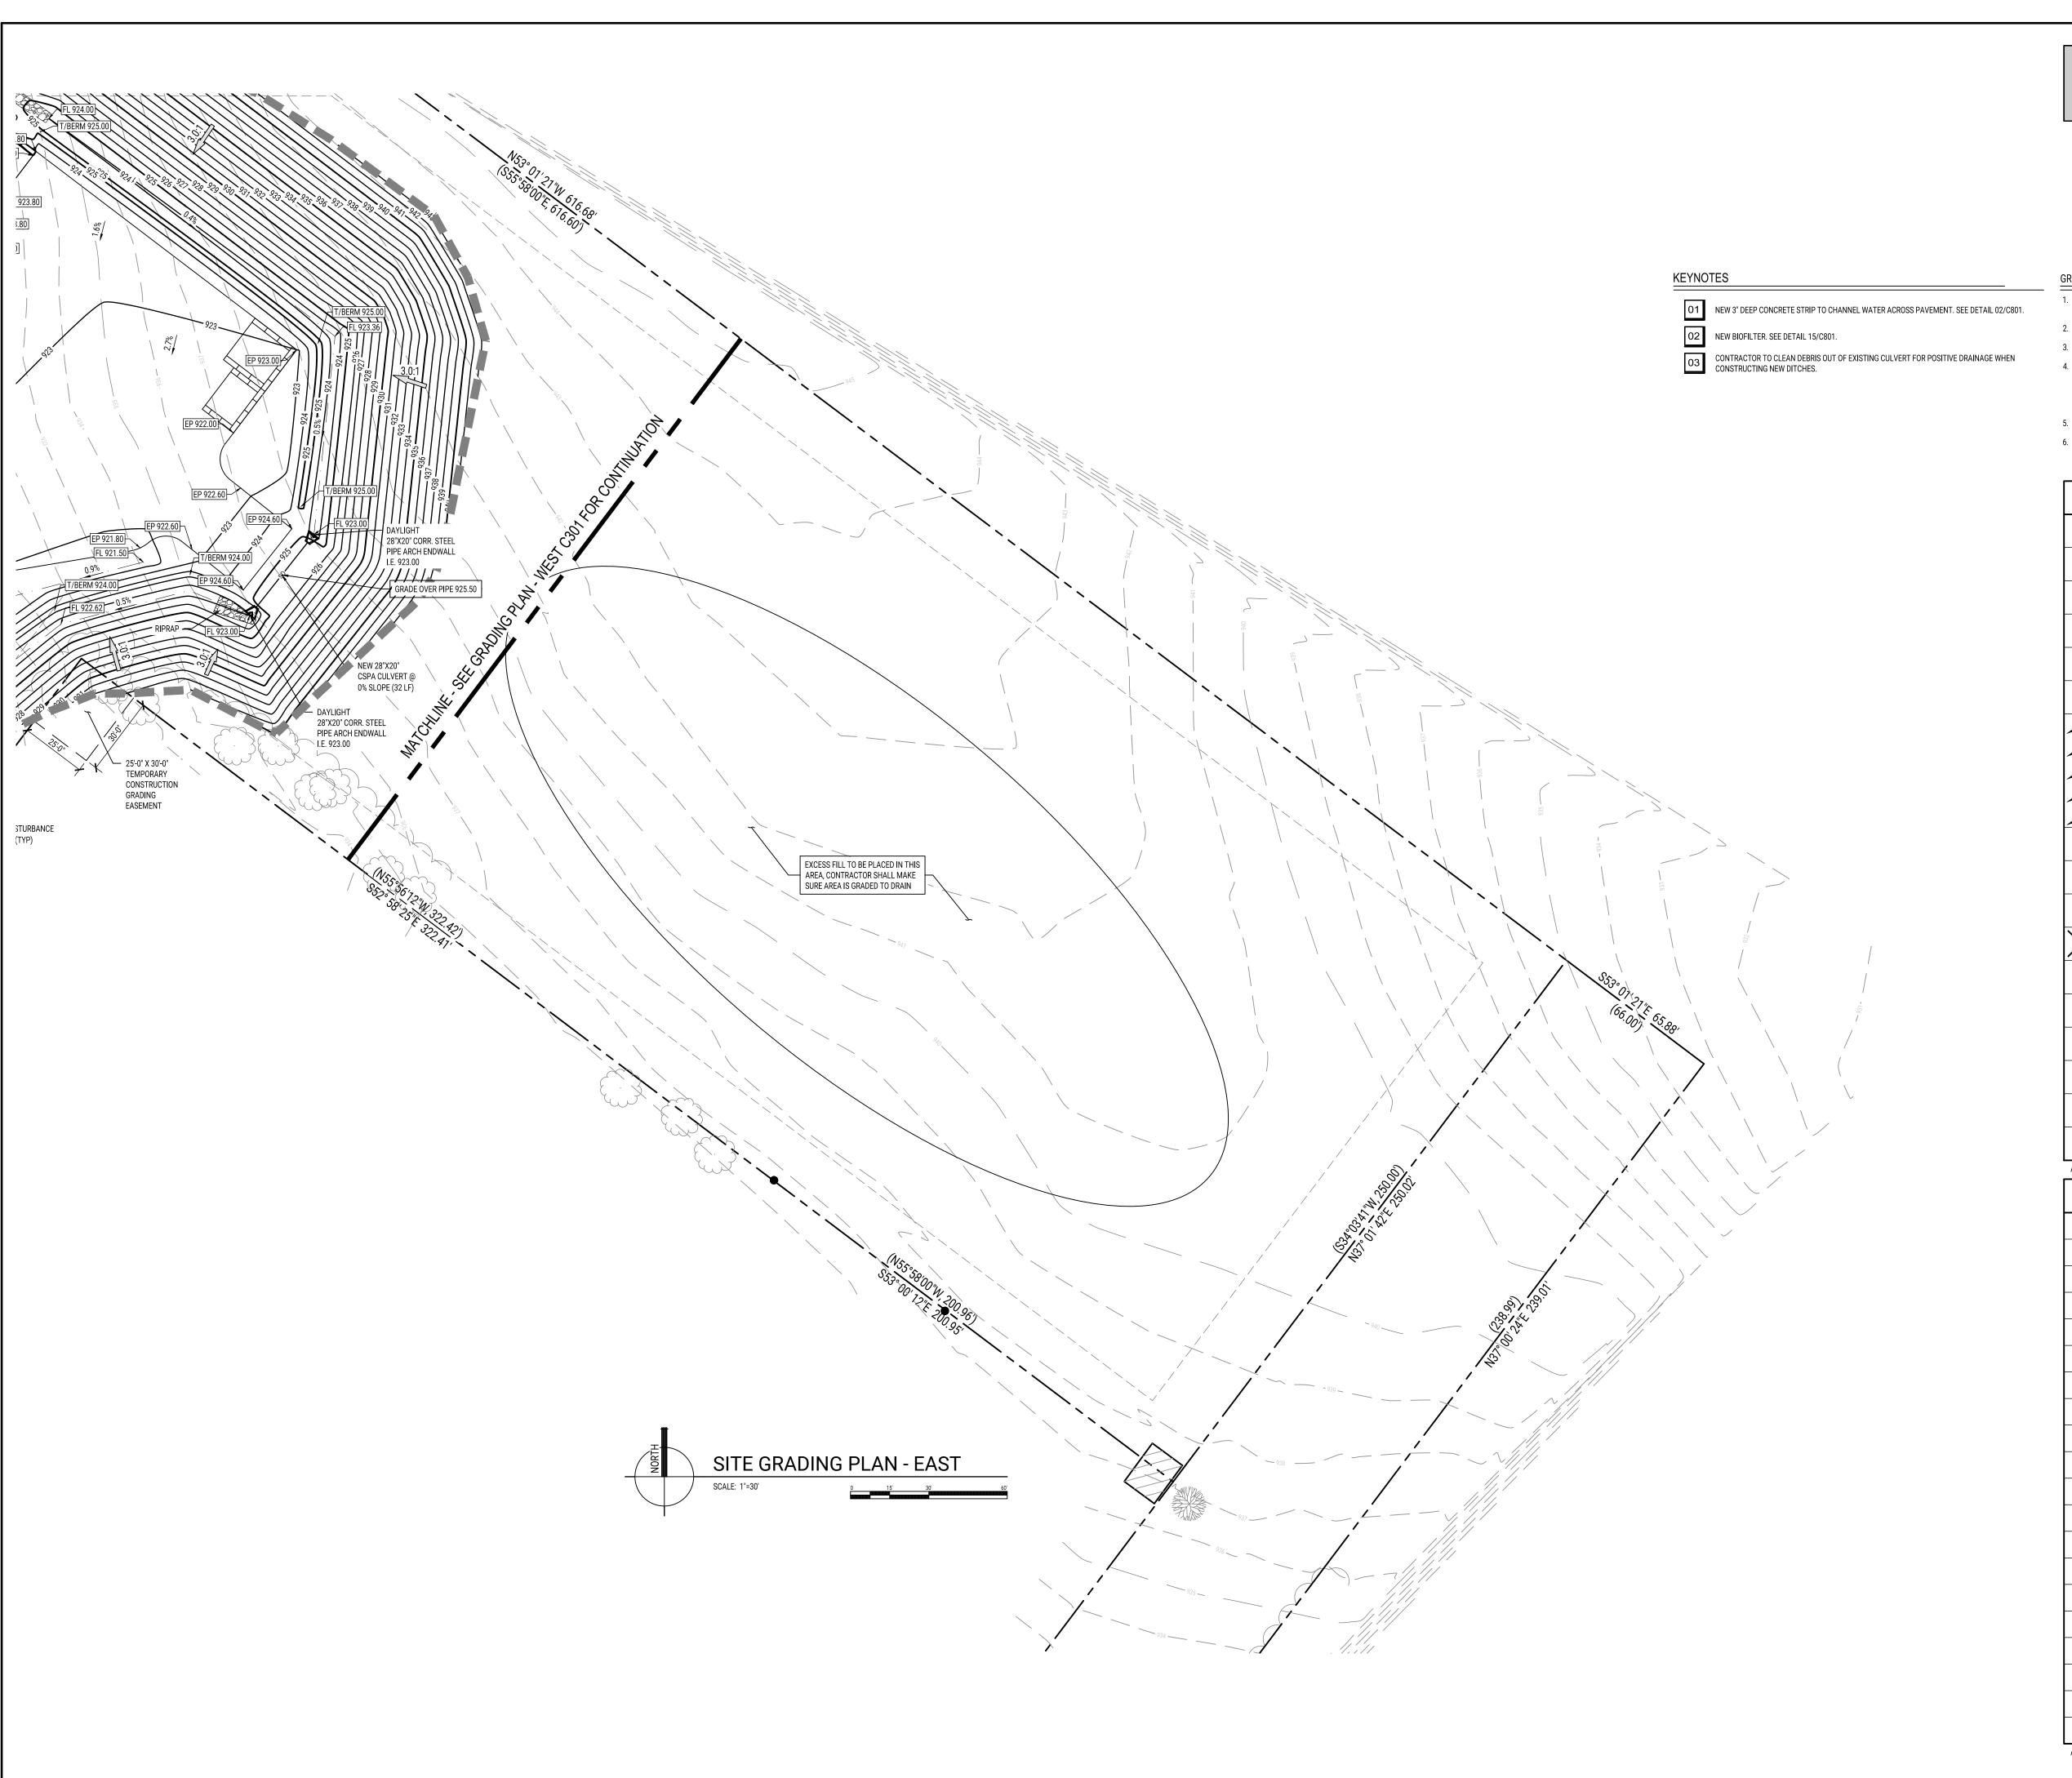
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REVIEWED B


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OVERALL SITE GRADING PLAN







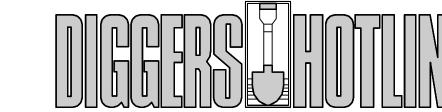

WISCONSIN STATUE 182.0175 (1974) REQUIRES A MINIMUM OF THREE (3) WORKING DAYS NOTICE PRIOR TO EXCAVATION.

#### GRADING NOTES CONSTRUCTION FENCING TO BE INSTALLED AROUND ENTIRE CONSTRUCTION SITE.

- COORDINATE WITH OWNER FOR FENCING AND GATE LOCATIONS AND APPROPRIATE SIGNAGE INSTALLATION.
- 2. REFER TO OTHER PROJECT PLANS AND INFORMATION RELATED TO THIS PROJECT PRIOR TO BEGINNING ANY GRADING WORK.
  3. CONTRACTOR SHALL LOCATE ALL UTILITIES THAT MAY AFFECT THEIR WORK AND NOTIFY OWNER OF ANY POTENTIAL CONFLICTS.
  4. CONTRACTOR SHALL VERIFY ALL EXISTING AND PROPOSED ELEVATIONS PRIOR TO THE PROPOSED SHADLY CONTRACTOR SHADLY CON START OF CONSTRUCTION. VERIFY CRITICAL ELEVATIONS TO ENSURE CONFORMANCE WITH GRADING PLAN, PARTICULARLY WITH WALK AND/ OR PAVEMENTS TO REMAIN.

MEET EXISTING GRADES ALONG STREETS, PROPERTY LINES AND DRIVEWAY ENTRANCES.

RESTORE ALL EXISTING PAVEMENTS THAT REMAIN TO THEIR ORIGINAL, IF NOT BETTER

- CONDITION. NOTIFY OWNER OF ANY CONFLICTS.

  AREAS NOT PAVED AND TO BE LANDSCAPED SHALL RECEIVE MINIMUM OF 4" DEPTH COMPACTED TOPSOIL.

  CONTRACTOR SHALL COORDINATE GRADING AND INSTALLATION OF DRIVES IN R.O.W. WITH APPROPRIATE GOVERNMENT AGENCIES. OBTAIN APPROPRIATE PERMITS FOR GRADING AND DRAINAGE IN ALL R.O.W.

SITE SYMBOL LEGEND					
<b>~</b>	SIGN				
<b>©</b>	BOLLARD				
В	FIRE HYDRANT				
0	MANHOLE/CATCH BASIN/INLET				
	CURB INLET				
September 1	NEW FLARED END SECTION WITH RIPRAP AND GUARD				
TP XXX.XX	FL XXX.XX  NEW FLOW LINE ELEVATION (FEET)  NEW TOP OF PAVEMENT ELEVATION (FEET)  NEW SIDEWALK ELEVATION (FEET)  NEW FINISH GRADE ELEVATION (FEET)  NEW FINISH GRADE ELEVATION (FEET)  NEW FINISH GRADE ELEVATION (FEET)				
[	TS XXX.XX NEW TOP AND BOTTOM OF				

ME XXX XX	ILEVATION (FEET) IEW MATCH EX. LEVATION (FEET)  TS XXX.XX BS XXX.XX STEP ELEVATION (FE				
RE / IE XXX.XX	RIM OR INVERT ELEVATION (FEET)				
8	WATER VALVE OR GAS VALVE				
(	GAS METER				
XO 8	LIGHT POLE				
<del></del>	UTILITY POLE				
>	GUY WIRE				
TR	TRANSFORMER				
E CT	ELECTRIC METER AND CT CABINET				
	NEW STRUCTURE OR ADDITION				

EXISTING STRUCTURE

ALL SYMBOLS MAY NOT BE USED IN THIS SET.

ALE STRIBUTES WAT NOT BE SOLD IN THIS SET.	
SITE LINE L	EGEND
	PROPERTY LINE
	SETBACK LINE
	EASEMENT LINE
	EXISTING INTERMEDIATE CONTOUR
	EXISTING INDEX CONTOUR
XXX	NEW INTERMEDIATE CONTOUR
XXX	NEW INDEX CONTOUR
	PAVEMENT
x x	FENCE
SDSDSD	STORM DRAIN
ssss	SANITARY SEWER
w	WATER
	GAS
P P P	ELECTRICAL POWER
PUPUPU	UNDERGROUND ELECTRICAL POWER
FOU	UNDERGROUND FIBER OPTIC
	TELEPHONE
титити	UNDERGROUND TELEPHONE
CATVCATV	CABLE

ALL SYMBOLS MAY NOT BE USED IN THIS SET.



**ROCK COUNTY** 

ORFORDVILLE SALT

734 W. BELOIT STREET ORFORDVILLE, WI 53576



NO: DESCRIPTION: 09.23.2022 01 VILLAGE SITE PLAN SUBMITTAL 01.13.2023 2 VILLAGE SITE PLAN SUBMITTAL 03 FOR BIDDING

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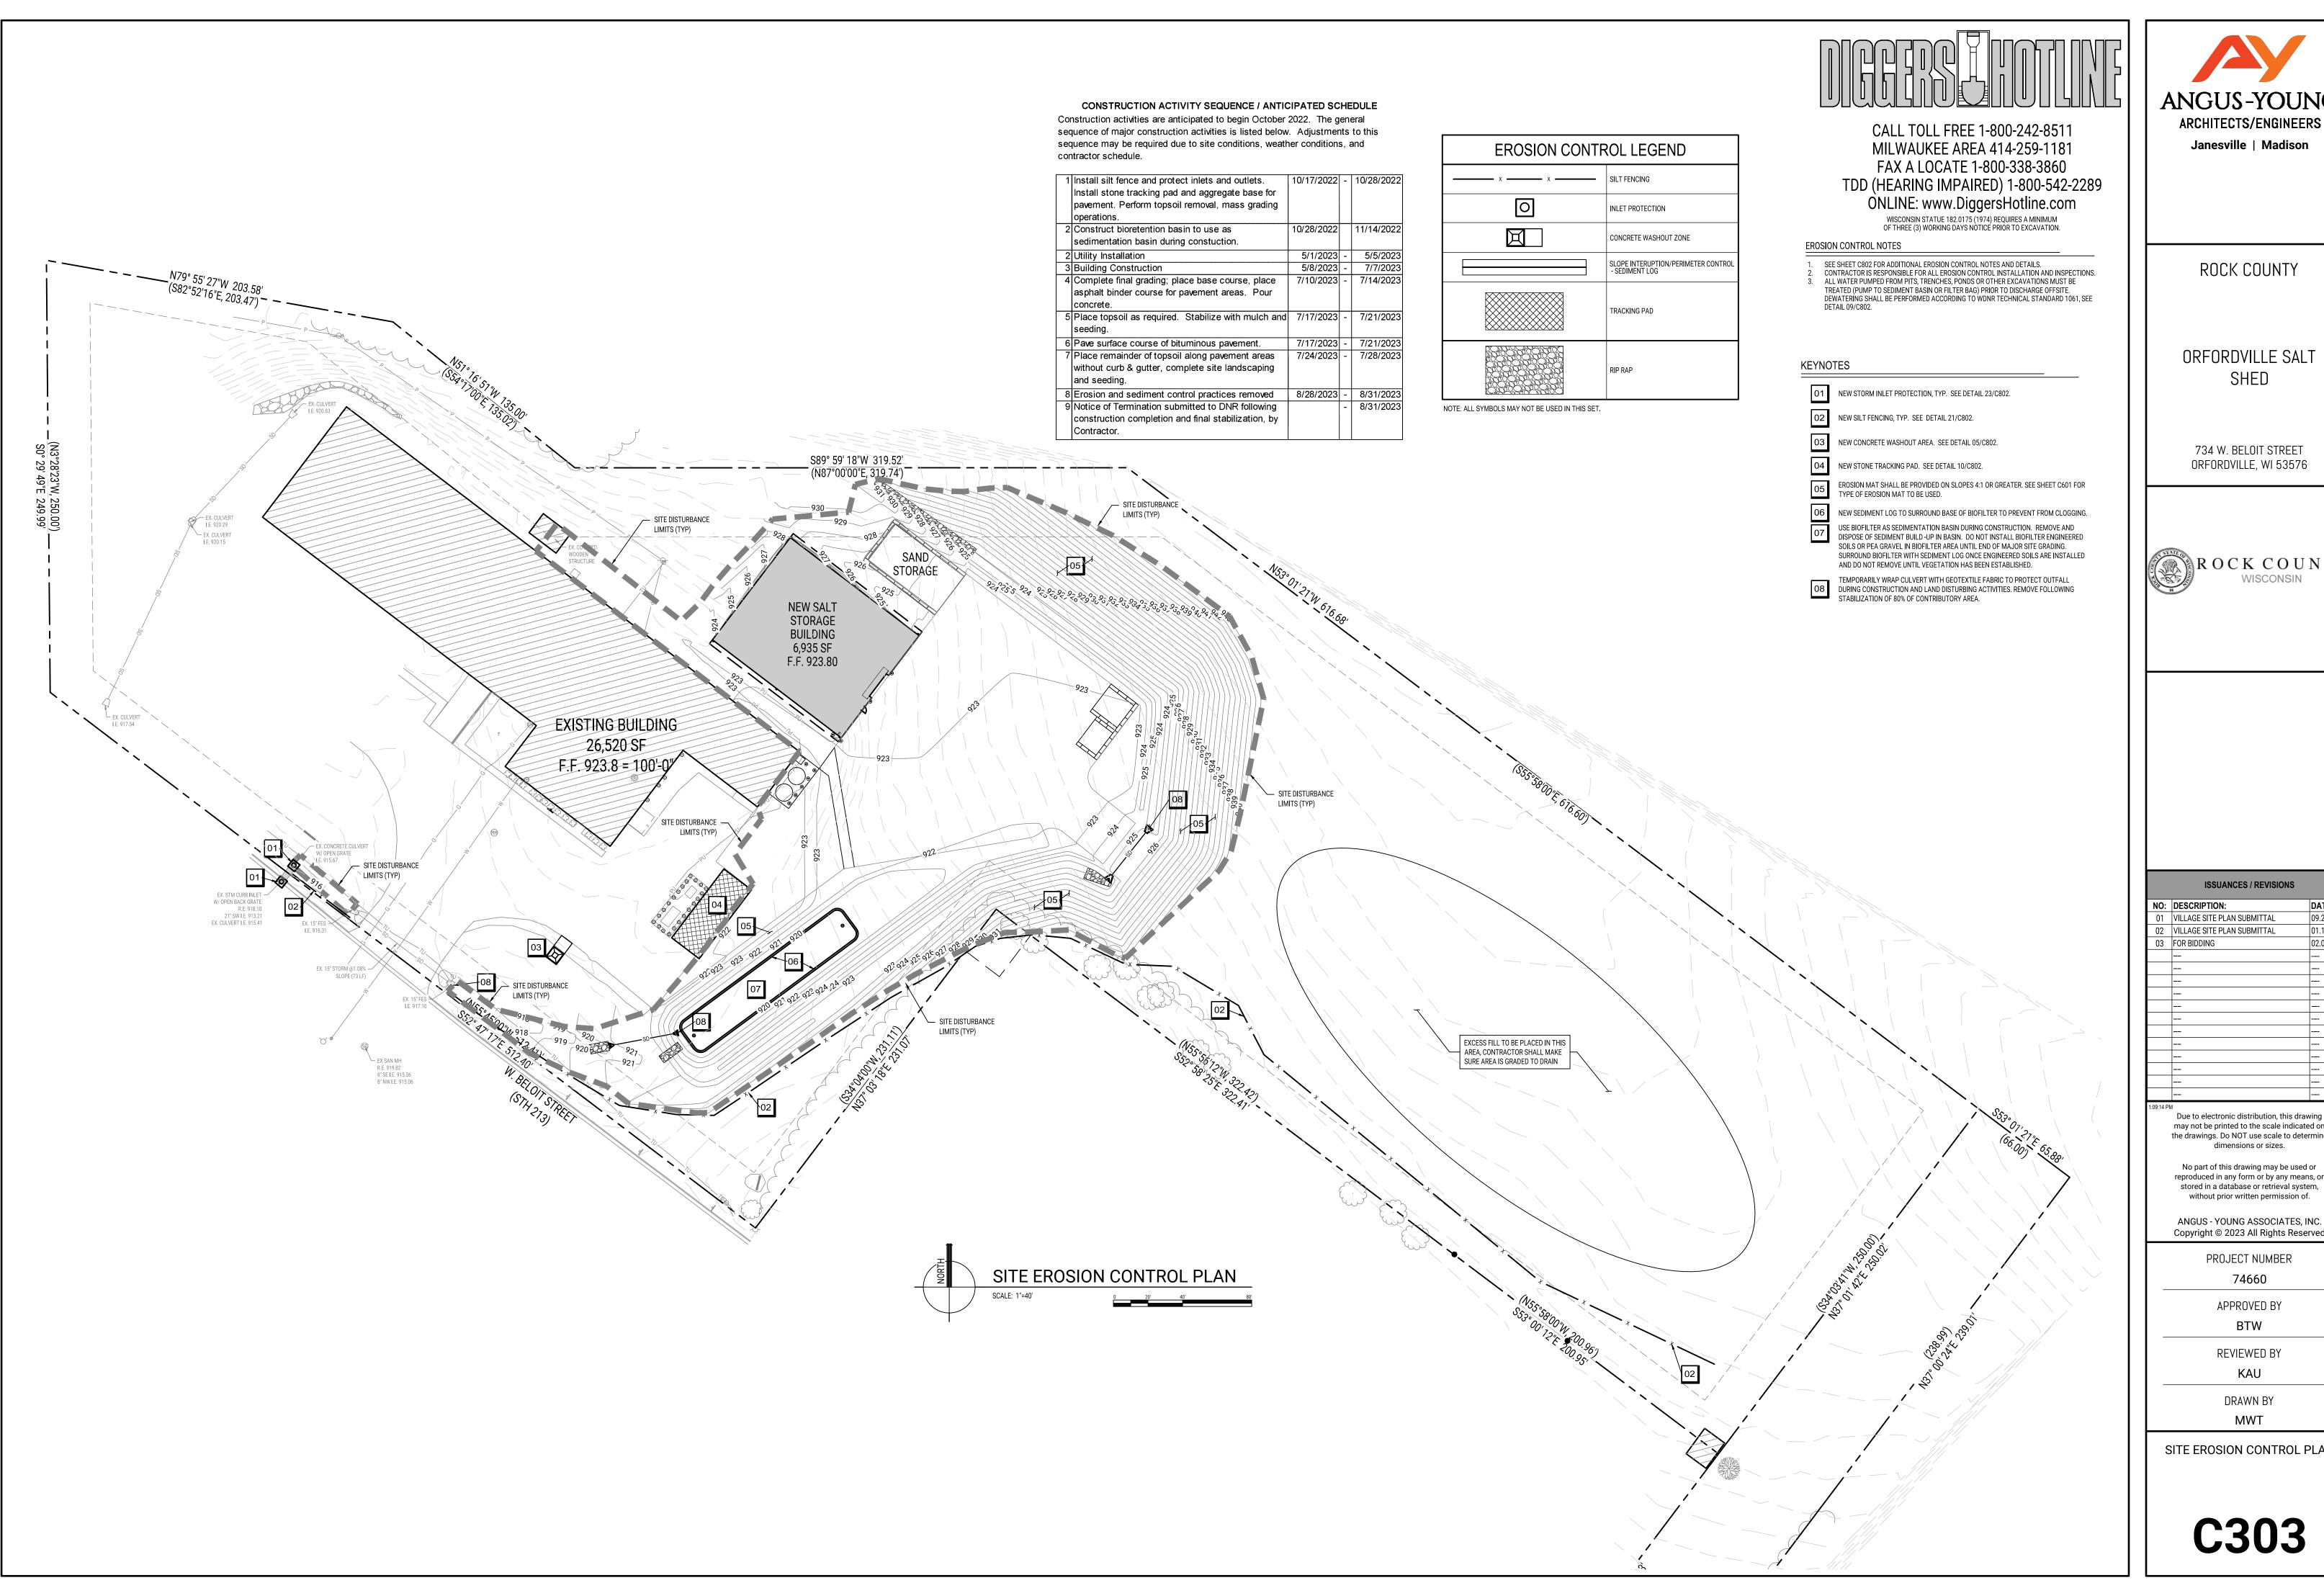
PROJECT NUMBER 74660

APPROVED BY

REVIEWED BY

DRAWN BY

SITE GRADING PLAN - EAST



**ANGUS-YOUNG** ARCHITECTS/ENGINEERS Janesville | Madison

ROCK COUNTY

ORFORDVILLE SALT

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09:14 PI	1	1/13/202

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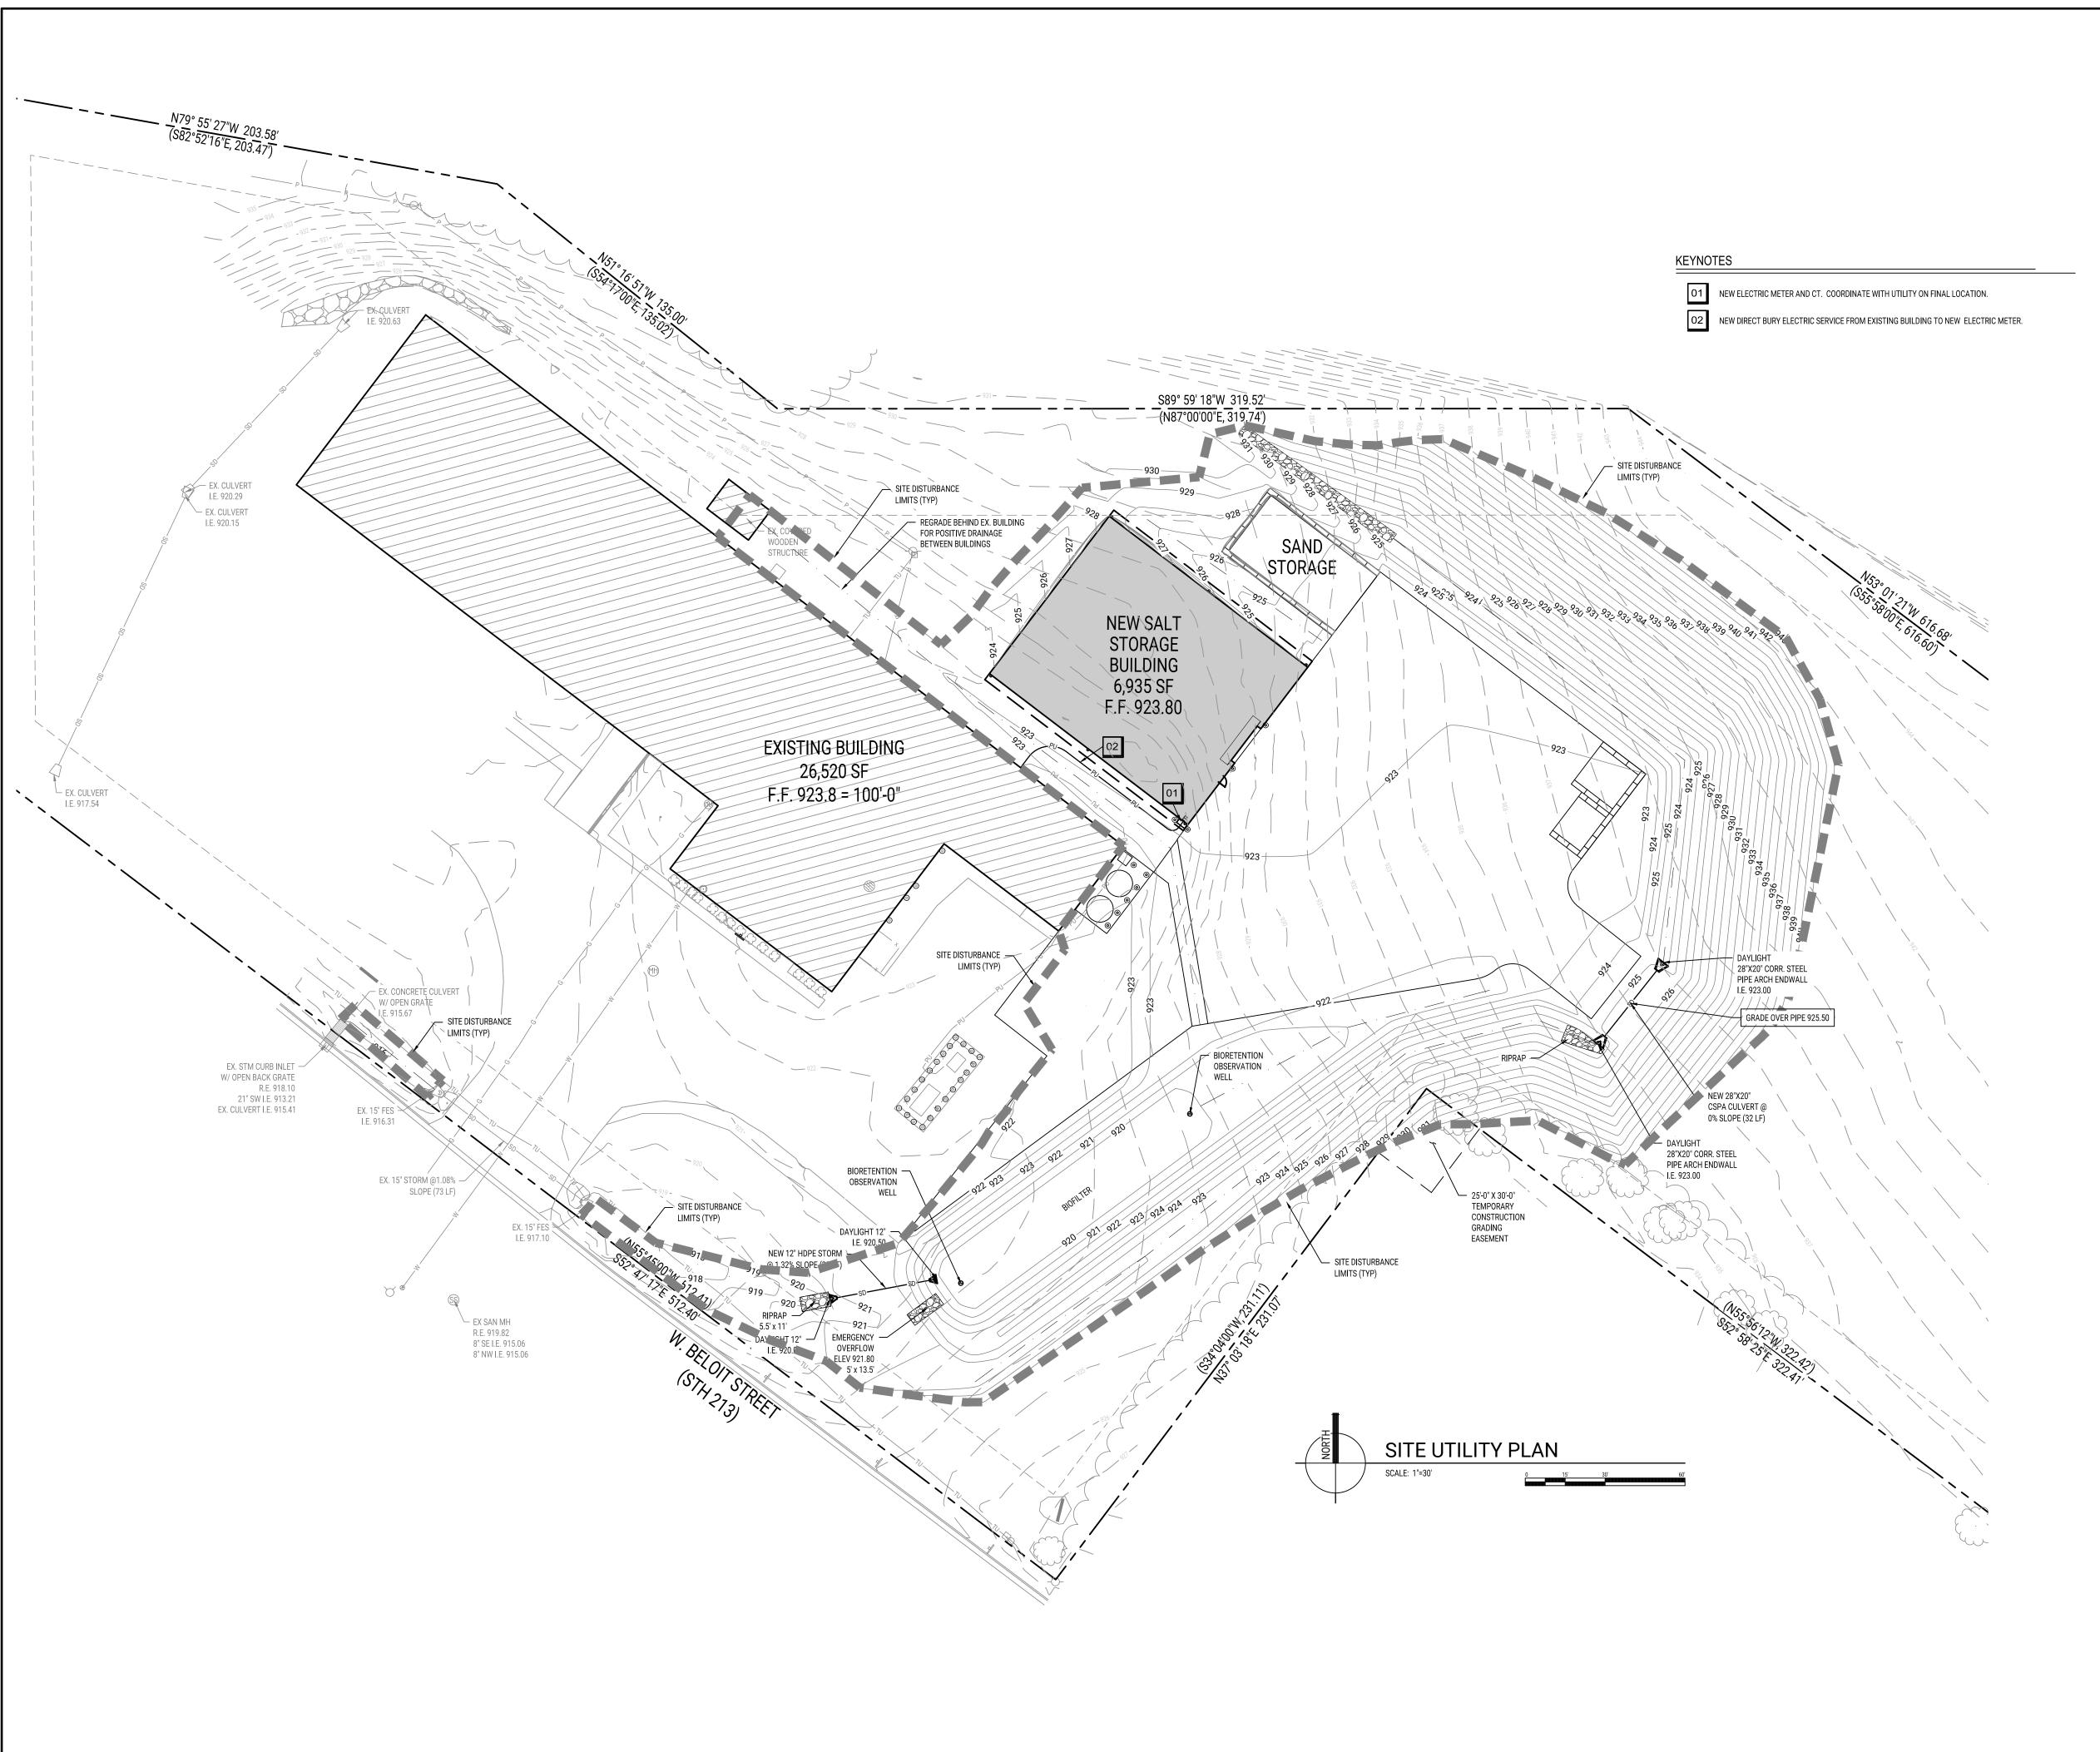
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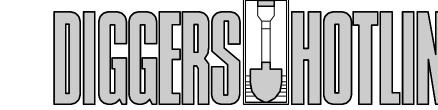
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PROJECT NUMBER 74660

DRAWN BY

SITE EROSION CONTROL PLAN





WISCONSIN STATUE 182.0175 (1974) REQUIRES A MINIMUM OF THREE (3) WORKING DAYS NOTICE PRIOR TO EXCAVATION. SITE UTILITY PLAN GENERAL NOTES

- 1. TRUE NORTH MAY VARY FROM PROJECT NORTH.
  2. CONSTRUCTION PRACTICES, MEANS AND METHODS, AND JOB SITE SAFETY, SHALL REMAIN THE SOLE RESPONSIBILITY OF THE CONTRACTOR.
  3. ALL WORK SHALL BE PERFORMED IN COMPLIANCE WITH THE FEDERAL OCCUPATIONAL HEALTH AND SAFETY ADMINISTRATION (OSHA), AND ALL FEDERAL, STATE AND LOCAL CODES AND ORDINANCES AS THEY PERTAIN TO THIS PROJECT.
  4. FIELD VERIFY ALL EXISTING AND PROPOSED UTILITIES, ELEVATIONS AND DIMENSIONS.
  5. COORDINATE RELOCATION OF ANY UTILITIES WITH THE UTILITY COMPANIES. NOTIFY THE ELECTRICAL UTILITY OF ANY EXCAVATION ADJACENT TO HIGH VOLTAGE LINES. PROTECT ALL LITH ITTES TO REMAIN.
- 6. DIGGERS HOTLINE SHALL BE CALLED TO MARK UTILITIES PRIOR TO LAND DISTURBANCE.
  7. COORDINATE WITH THE AUTHORITY HAVING JURISDICTION AND UTILITY COMPANIES AS
- NECESSARY.

  8. PROVIDE THRUST BLOCKING AND PIPE JOINT RESTRAINT FOR DUCTILE IRON WATER LATERALS.
  PROVIDE WATER CONNECTIONS AND CONTROL VALVES IN ACCORDANCE WITH STATE AND
  LOCAL REQUIREMENTS.

  9. CONTRACTOR SHALL RESTORE CURB AND GUTTER AND PAVEMENT WORK TO MEET
- AUTHORITY HAVING JURISDICTION REQUIREMENTS. SAWCUT PAVEMENT TO PROVIDE CLEAN
- 10. TRACER WIRE SHALL BE INSTALLED ABOVE ALL SANITARY, STORM AND WATER LATERALS THAT CONNECT TO A PUBLIC UTILITY. TRACER WIRE SHALL BE A MINIMUM OF 12 GAUGE, THAT CONNECT TO A PUBLIC UTILITY. TRACER WIRE SHALL BE A MINIMUM OF 12 GAUGE,
  PLASTIC-COATED COPPER WIRE BURIED WITHIN 6" AND DIRECTLY ABOVE THE TOP OF THE PIPE.
  THE TRACER WIRE SHALL BE BROUGHT TO THE SURFACE AT LEAST EVERY 400'. PROTECT THE
  WIRE AT THE ACCESS POINTS. THE COLOR OF THE TRACER WIRE SHALL BE AS FOLLOWS:
  - GREEN FOR SANITARY SEWER
  - BROWN FOR STORM SEWER
  - BLUE FOR POTABLE WATER

  11. PROVIDE TRENCH BEDDING PER DETAIL 08/C801. UTILITY TRENCHES UNDER CONCRETE
  PAVEMENT SHALL UTILIZE FLOWABLE FILL IN AREAS DIFFICULT TO COMPACT TO PREVENT
  CONCRETE CRACKING.
- PROVIDE MIN. 7'-0" COVER OVER WATER LATERAL. SEE GRADING PLAN SHEET FOR EXISTING AND PROPOSED GRADES. COORDINATE AS NECESSARY, PARTICULARLY AROUND STORMWATER
- FACILITIES. PROVIDE MIN. 18" CLEARANCE UNDER OR 12" CLEARANCE OVER SANITARY AND STORM SEWER PIPES.

  13. ALL SANITARY, STORM, AND WATER UTILITY WORK WITHIN PUBLIC RIGHT OF WAY SHALL CONFORM TO AUTHORITY HAVING JURISDICTION REQUIREMENTS AND STANDARD SPECIFICATIONS.
- 14. RESTORE ALL AREAS TO SEEDED LAWN UNLESS NOTED OTHERWISE.

14. RESTORE ALL AREAS TO	RESTORE ALL AREAS TO SEEDED LAWN UNLESS NOTED OTHERWISE.					
SI	TE SYMBOL LEGEND					
<del>+</del>	SIGN					
0	BOLLARD					
A	FIRE HYDRANT					
0	MANHOLE/CATCH BASIN/INLET					
	CURB INLET					
	NEW FLARED END SECTION WITH RIPRAP AND GUARD					
8	WATER VALVE OR GAS VALVE					
	GAS METER					
XO 8	LIGHT POLE					
<del></del>	UTILITY POLE					
<b>&gt;</b>	GUY WIRE					
TR	TRANSFORMER					
E CT	ELECTRIC METER AND CT CABINET					
	NEW STRUCTURE OR ADDITION					
	EXISTING STRUCTURE					

### ALL SYMBOLS MAY NOT BE USED IN THIS SET. SITE LINE LEGEND

	PROPERTY LINE
	SETBACK LINE
	EASEMENT LINE
XXX	EXISTING INTERMEDIATE CONTOUR
XXX	EXISTING INDEX CONTOUR
XXX	NEW INTERMEDIATE CONTOUR
XXX	NEW INDEX CONTOUR
	PAVEMENT
x x	FENCE
SDSDSD	STORM DRAIN
ssss	SANITARY SEWER
w	WATER
G	GAS
P — P — P — P — P — P — P — P — P — P —	ELECTRICAL POWER
PU	UNDERGROUND ELECTRICAL POWER
FOU——FOU—	UNDERGROUND FIBER OPTIC
	TELEPHONE
TUTUTU	UNDERGROUND TELEPHONE
CATVCATV	CABLE
	EDGE OF TREES OR SHRUBS



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	ISSUANCES / REVISIONS						
):	DESCRIPTION:	DATE:					
1	VILLAGE SITE PLAN SUBMITTAL	09.23.20					
2	VILLAGE SITE PLAN SUBMITTAL	01.13.20					
3	FOR BIDDING	02.01.20					

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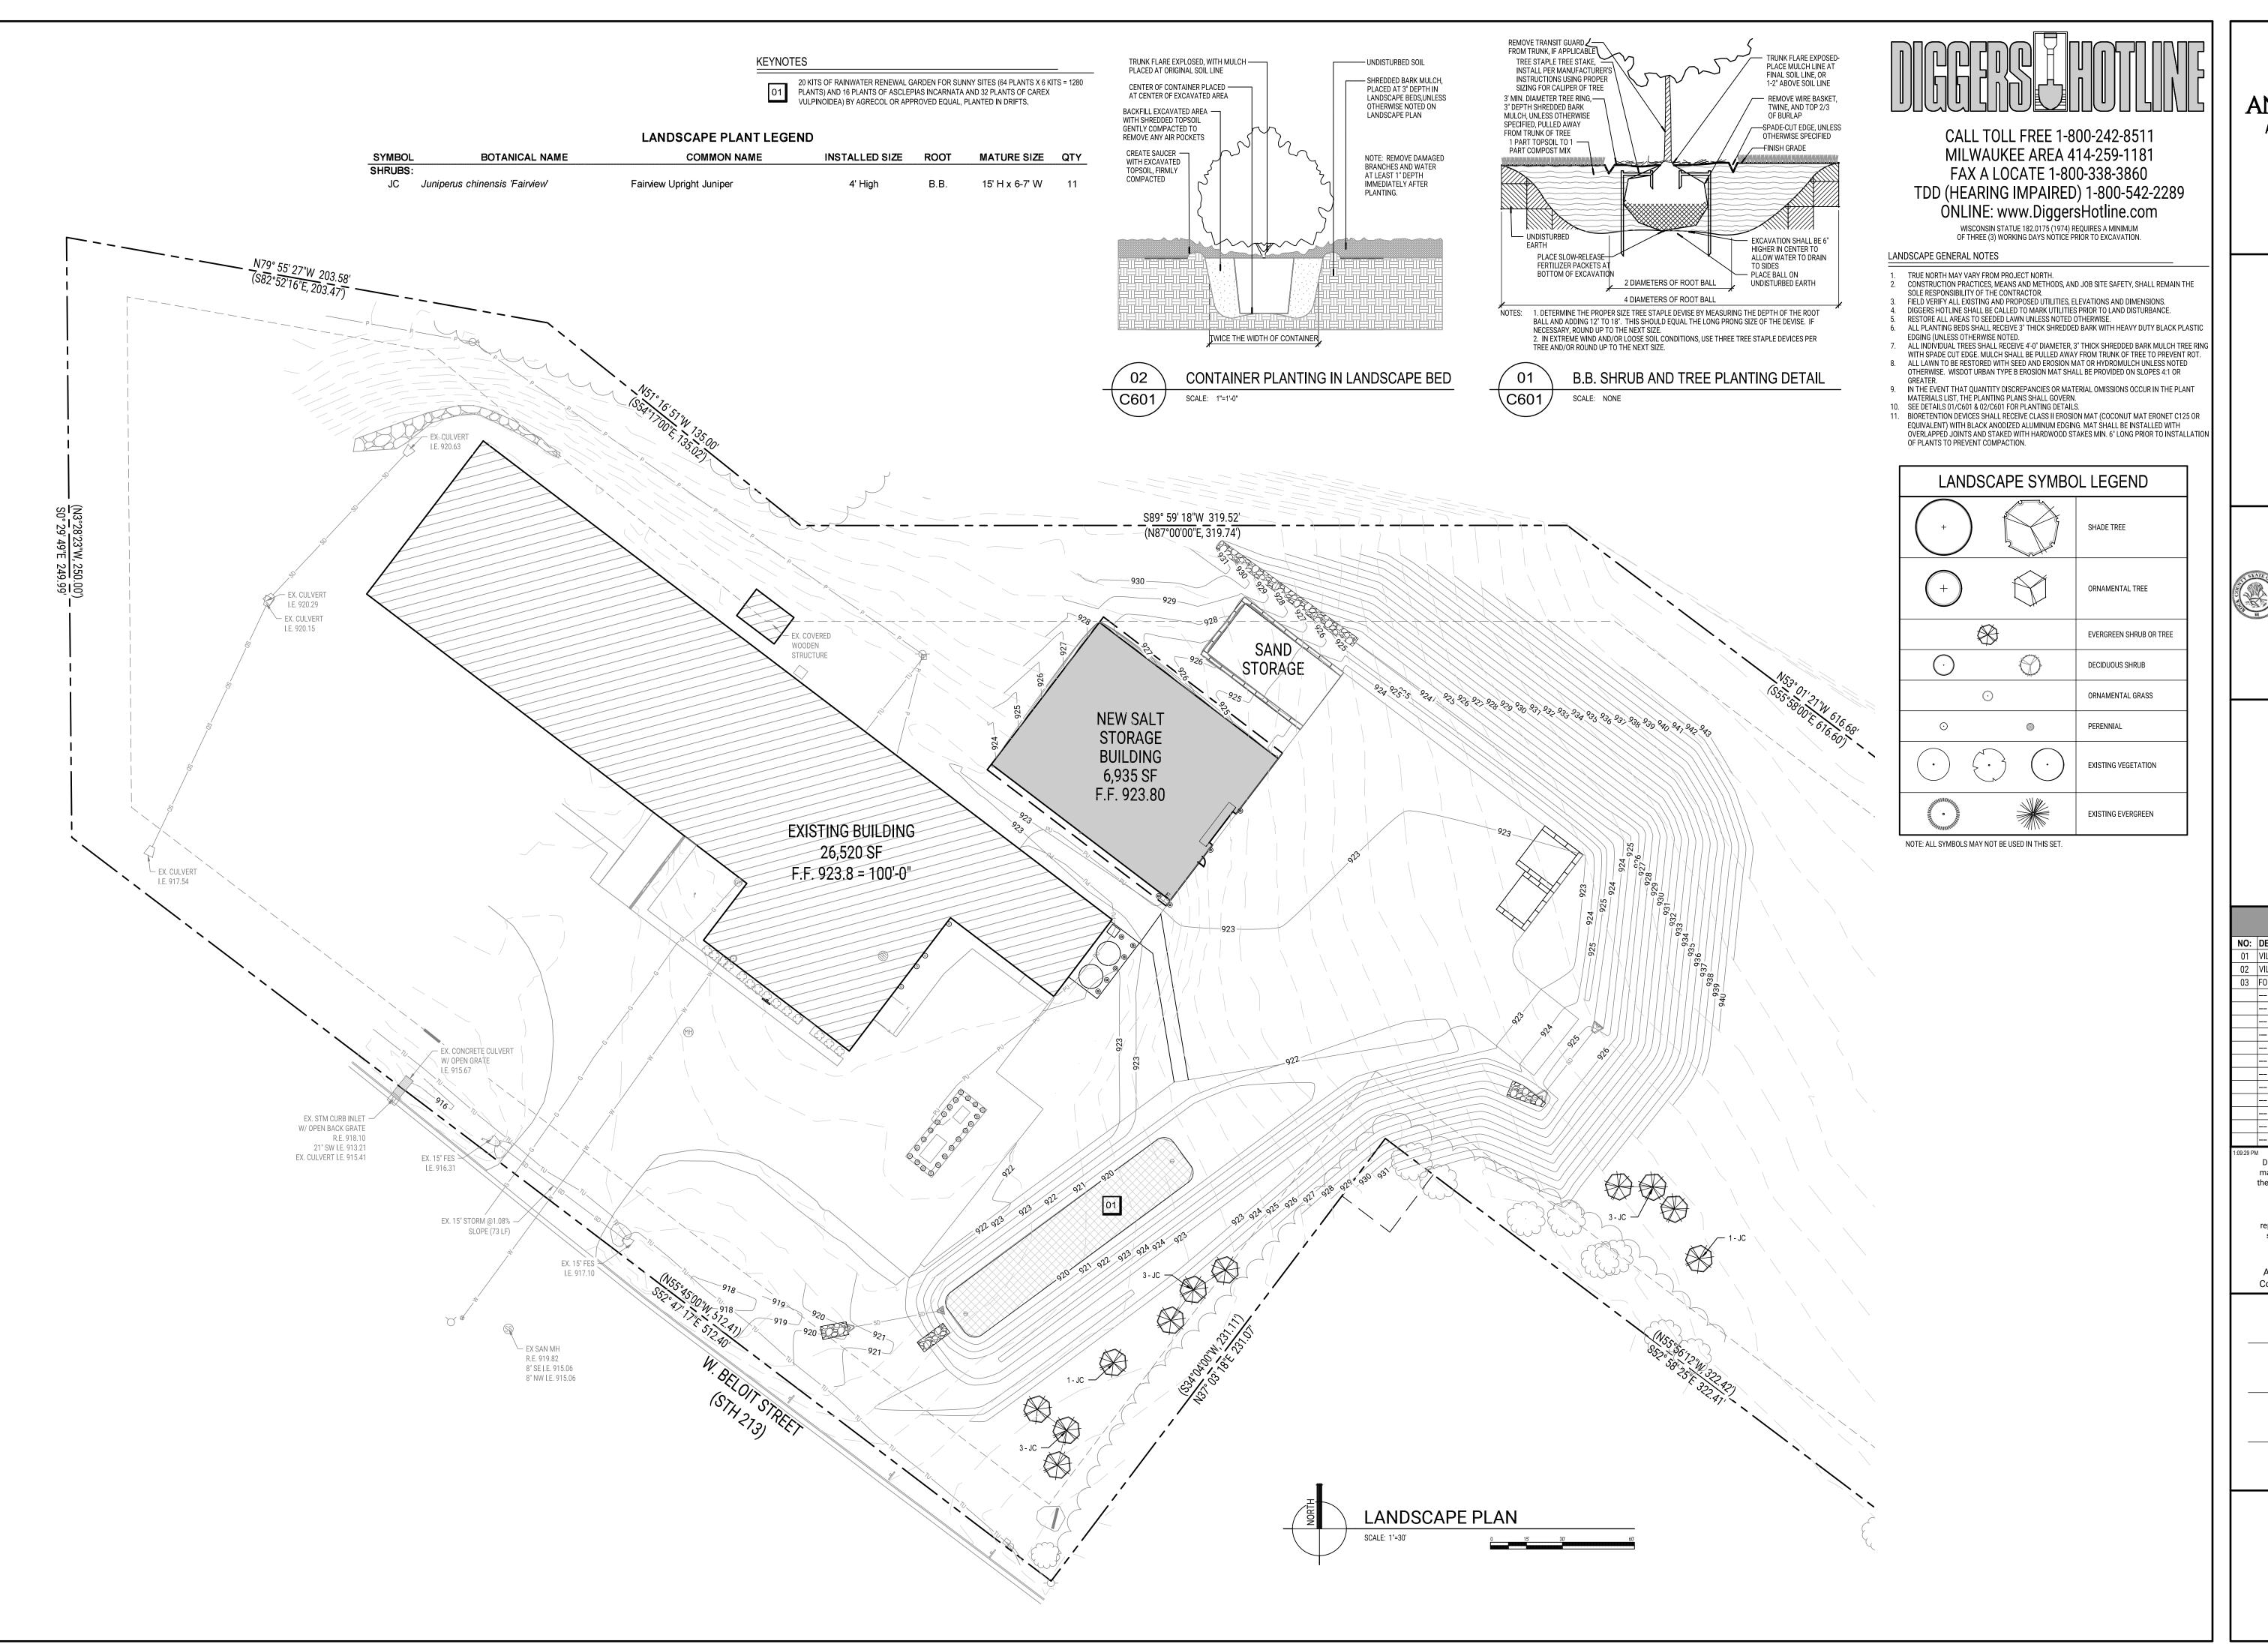
> PROJECT NUMBER 74660

> > APPROVED BY BTW

REVIEWED BY

DRAWN BY

SITE UTILITY PLAN



ANGUS-YOUNG
ARCHITECTS/ENGINEERS
Janesville | Madison

**ROCK COUNTY** 

ORFORDVILLE SALT SHED

734 W. BELOIT STREET ORFORDVILLE, WI 53576



 NO:
 DESCRIPTION:
 DATE:

 01
 VILLAGE SITE PLAN SUBMITTAL
 09.23.2022

 02
 VILLAGE SITE PLAN SUBMITTAL
 01.13.2023

 03
 FOR BIDDING
 02.01.2023

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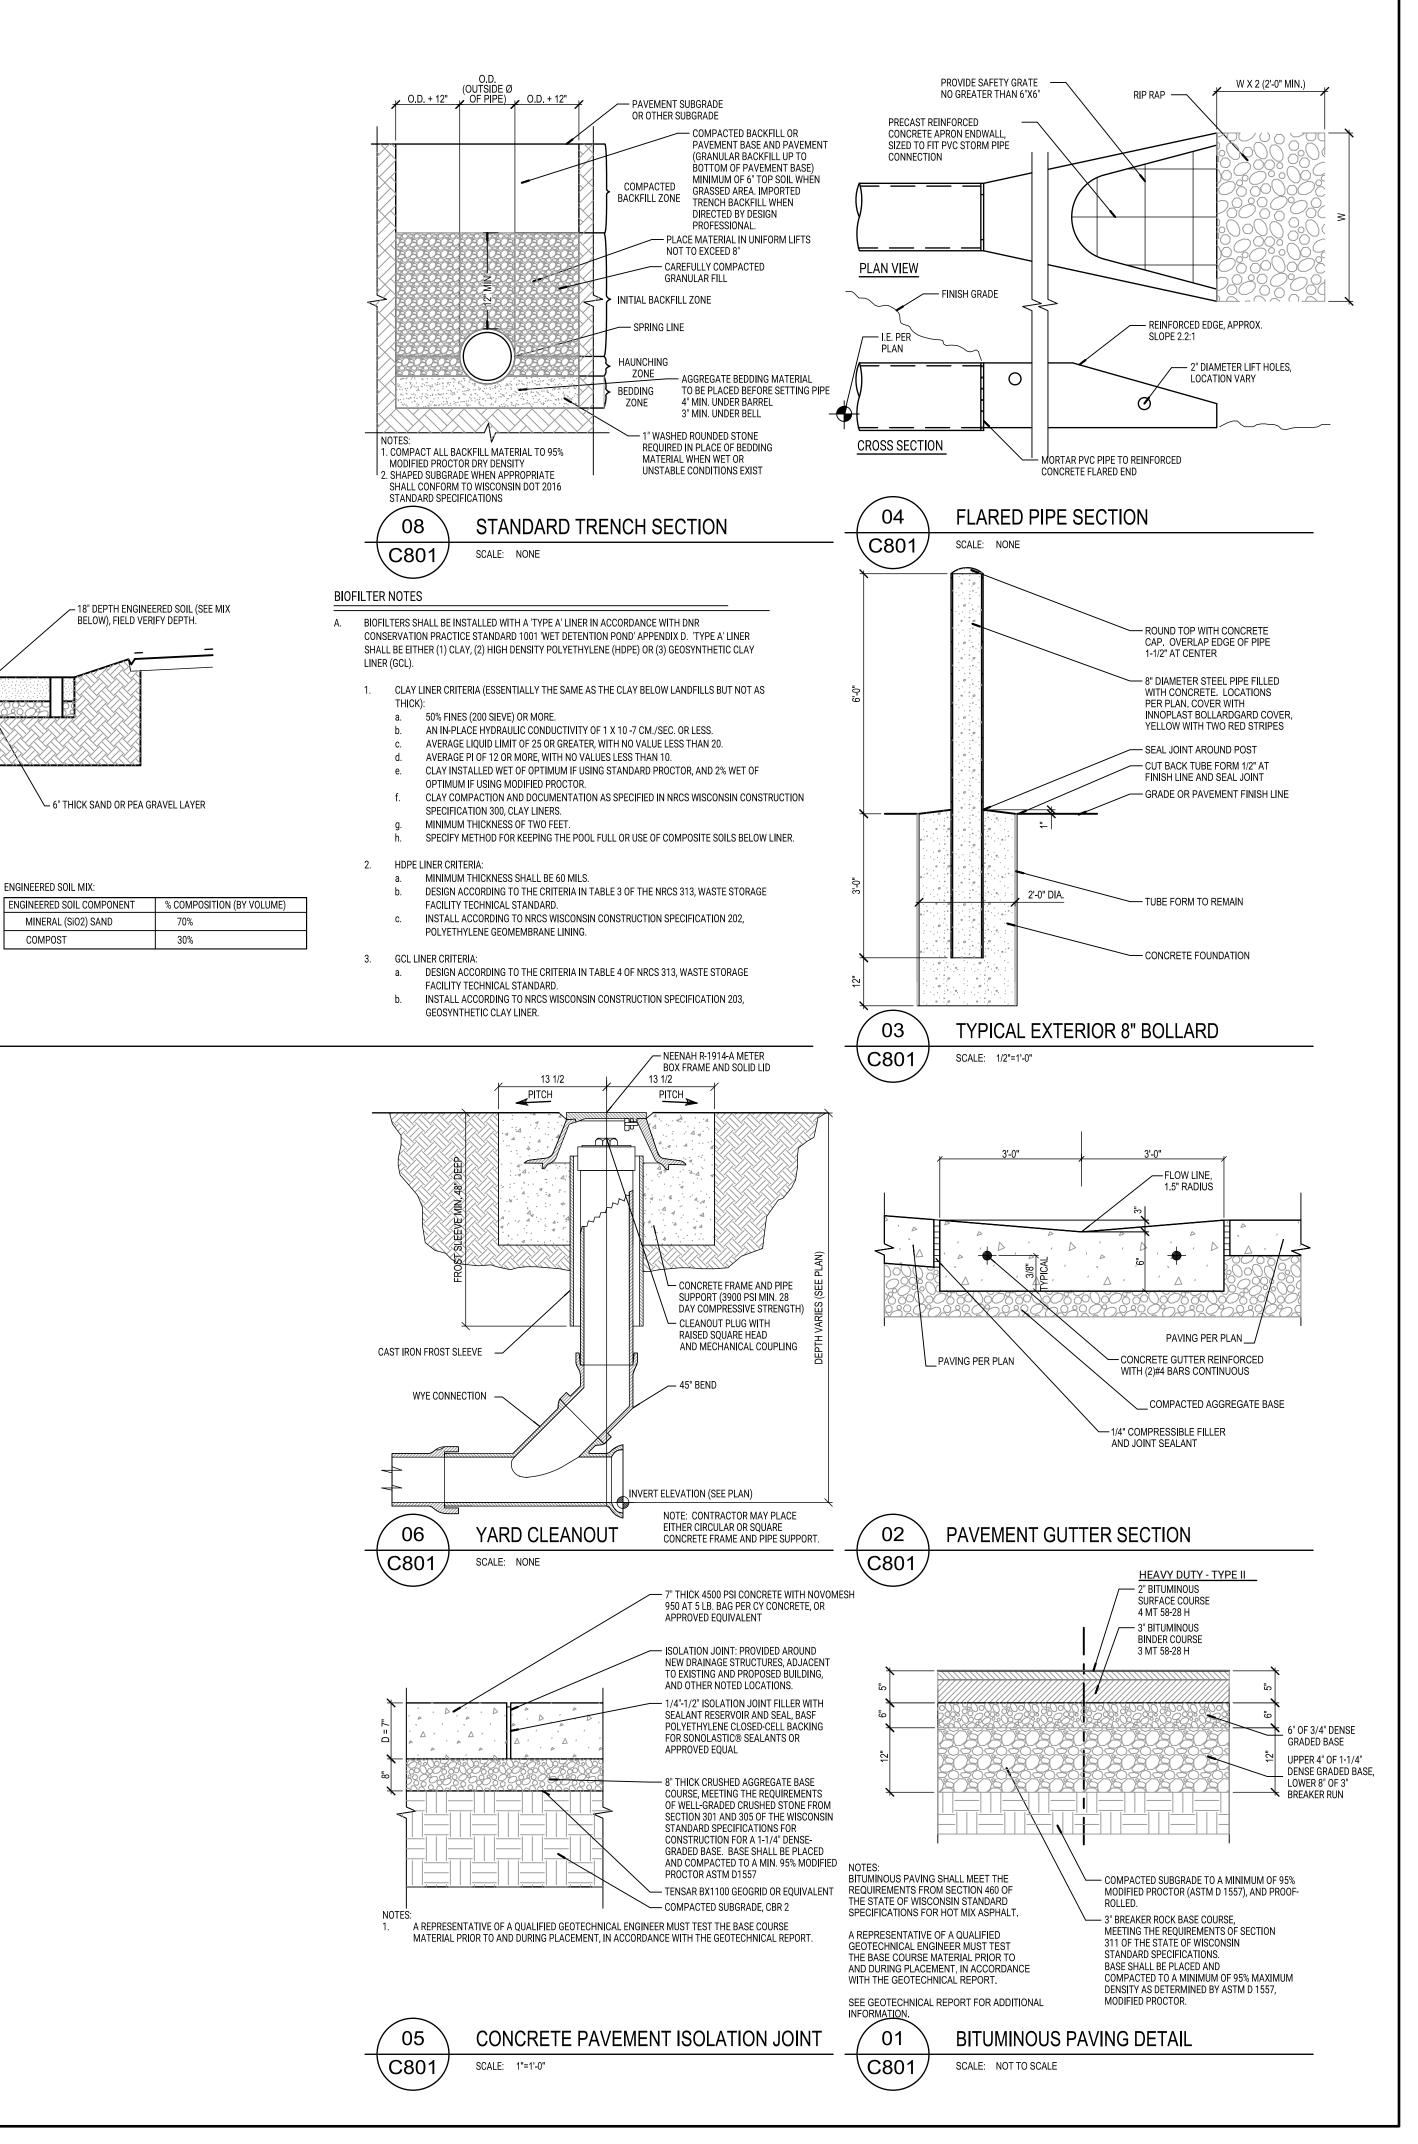
REVIEWED BY

KAU

MWT

DRAWN BY

LANDSCAPE PLAN



GRADE OF BIORETENTION DEVICE —

06/C801 WITHOUT CONCRETE FRAME

AND NO PIPE CONNECTION.

SAND SHALL MEET STANDARDS FOR FINE AGGREGATE CONCRETE SAND IN THE WISCONSIN STANDARDS
 AND SPECIFICATIONS FOR HIGHWAY CONSTRUCTION, SECTION 501.2.5.3.4, 2005 EDITION, OR APPROVED
 EQUAL. SAND SHALL CONSIST OF AT LEAST 97% SiO2. SUBSTITUTIONS ARE NOT ALLOWED. SAND SHALL

COMPOST SHALL MEET THE REQUIREMENTS OF THE WISCONSIN DNR SPECIFICATION S100, COMPOST.

THE ENGINEERED SOIL MIX SHALL BE PLACED IN 6" LIFTS. DEPTH OF SOIL SHALL ACCOMMODATE COMPACTION.

THE ENGINEERED SOIL SHALL BE UNIFORM, FREE OF STONES, STUMPS, ROOTS, OR OTHER SIMILAR

BE WASHED PRIOR TO MIXING.

SCALE: NONE

OBJECTS LARGER THAN 1" IN DIAMETER.

THE ENGINEERED SOIL MIX SHALL HAVE A pH BETWEEN 5.5 AND 6.5

**BIORETENTION DEVICE SECTION** 

TOP 920.00

24" THICK CLAY LINER TYPE "A",

OR EQUAL UNDER ENTIRE BASIN.

SEE SPECIFICATION NOTES ON

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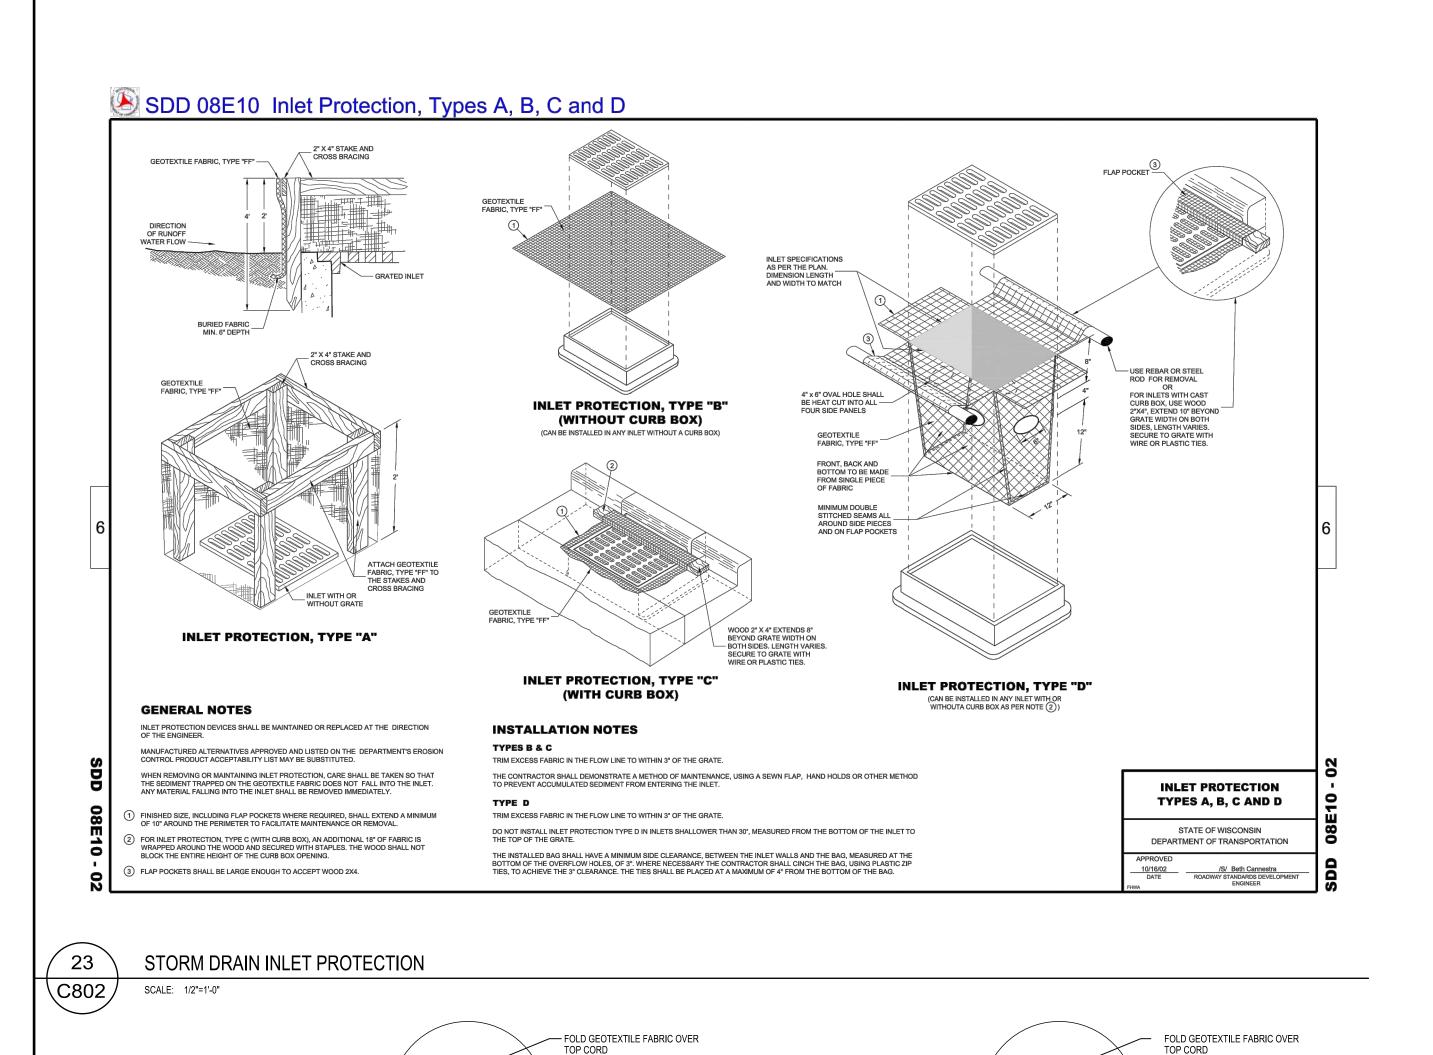
APPROVED BY
BTW

REVIEWED BY

KAU

MWT
SITE DETAILS

DRAWN BY



- HEAVY DUTY NYLON TOP CORD

- 14 GAGE MINIMUM WIRE RING AT

NON-WOVEN GEOTEXTILE FABRIC

POST PLACEMENT ALTERNATE "B"

WITHOUT SUPPORT NETTING

NOTE: CONSTRUCT THE SILT FENCE IN AN ARC OR HORSESHOE SHAPE, WITH THE ENDS


NOTE: POINT A SHALL BE HIGHER

THAN POINT B

**ELEVATION VIEW** 

TURNED UPSLOPE

SUPPORT NETTING — GEOTEXTILE FABRIC

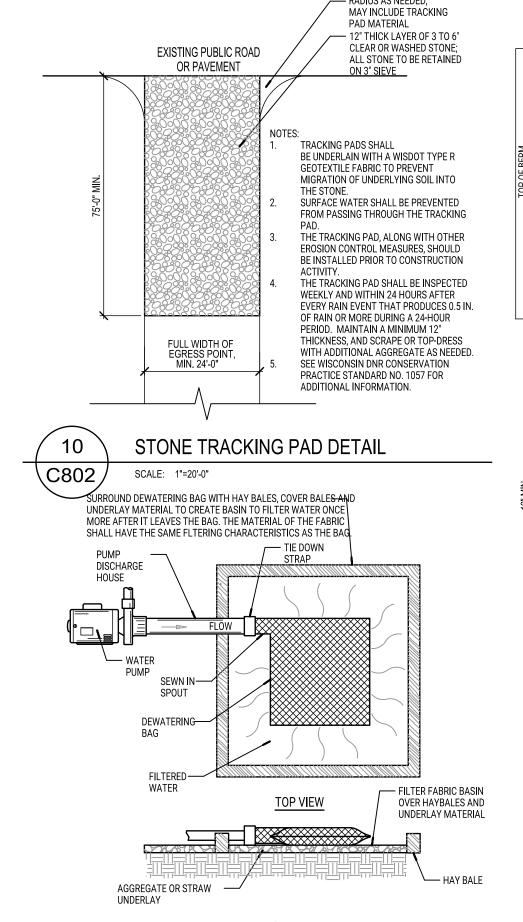

**DEWATERING DETAIL** 

SCALE: NOT TO SCALE

HEAVY DUTY NYLON TOP CORD

GEOTEXTILE FABRIC

TOP SUPPORT DETAIL

SPECIAL PROVISIONS.

14 GAGE MINIMUM WIRE RING AT

1. CONSTRUCTION SHALL CONFORM TO THE PERTINENT REQUIREMENTS

2. ALTERNATES A & B ARE EQUAL AND EITHER MAY BE USED.

3. INSTALL SILT FENCING PRIOR TO DISTURBING UP SLOPE AREAS.

CROSS BRACE WITH 2" X 4" WOODEN FRAME OR EQUIVALENT AT

02 EXCAVATE A 4" WIDE x 4" DEEP TRENCH ALONG INTENDED FENCE

GEOTEXTILE FABRIC SHALL BE REINFORCED WITH AN INDUSTRIAL POLYPROPYLENE NETTING WITH A MAXIMUM MESH SPACING OF 3/4"

STEEL: STUDDED "TEE" OR "U" TYPE WITH A MINIMUM WEIGHT

4" DIAMETER ROUND PRESSURE TREATED

MAINTAIN AND INSPECT FENCE WITHIN 24 HOURS AFTER EACH

REMOVE SEDIMENT DEPOSITS AFTER EACH STORM EVENT OR WHEN

BLOWN OVER(LAYING DOWN), SHOWS A LACK OF MATERIAL INTEGRITY,

DEPOSITS REACH 1/2 FENCE HEIGHT, WHICHEVER OCCURS FIRST

REPAIR OR REPLACE FENCE WHEN TORN, SAGGING, OVERTOPPED

OF 1,28 LBS/LINEAL FOOT WITH FIN ANCHORS SUFFICIENT

1-1/2" x 3-1/2" PRESSURE TREATED WITH STRONG DIRECTION

INE TO BURY AND ANCHOR THE GEOTEXTILE FABRIC. FOLD FABRIC O FIT TRENCH AND BACKFILL & COMPACT TRENCH WITH

TOP OF POSTS AS DIRECTED BY THE ARCHITECT.

704 FENCE POSTS SHALL BE AS FOLLOWS:

WOOD: 1-1/8" x 1-1/8" OAK OR HICKORY

ORIENTED WITH THE SLOPE


RAINFALL OR DAILY DURING PROLONGED RAINFALL

OR IN ANY WAY IS NOT FUNCTIONING AS DESIGNED.

4. REMOVE FENCING WHEN SOIL HAS BEEN PERMANENTLY STABILIZED.

OF THE STANDARD SPECIFICATIONS, THE WISCONSIN CONSTRUCTION

SITE BEST MANAGEMENT PRACTICE HANDBOOK, AND ANY APPLICABLE

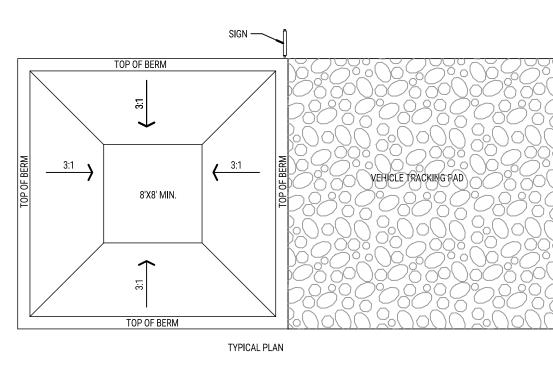

**EROSION CONTROL NOTES** 

1 POST WDNR CERTIFICATE OF PERMIT COVERAGE ON SITE PRIOR TO

THE CONTRACTOR SHALL OBTAIN A NOTICE OF TERMINATION WITH

TEMPORARY EROSION AND SEDIMENT CONTROLS HAVE BEEN REMOVED, AND ALL DISTURBED AREAS HAVE PERENNIAL COVER OF

3 KEEP A COPY OF THE CURRENT EROSION CONTROL PLAN ON SITE

5 CONTRACTOR IS RESPONSIBLE FOR ROUTINE SITE INSPECTIONS AT

RAINFALL EVENT OF 0.5 INCHES OR GREATER. KEEP INSPECTION REPORTS ON-SITE AND MAKE THEM AVAILABLE UPON REQUEST.

6 CONTRACTOR SHALL MAINTAIN A WEEKLY REPORT OF THE EROSION

AND SEDIMENT CONTROL MEASURES AND CONDUCT MAINTENANCE

TO ENSURE THE MEASURES ARE IN PROPER WORKING ORDER. THE

MONITORING RECORD SHALL INCLUDE AT LEAST THE FOLLOWING:

AN ASSESSMENT OF THE CONDITION OF EROSION AND SEDIMENT

A DESCRIPTION OF THE SITE'S PRESENT PHASE OF CONSTRUCTION

PRACTICES UNTIL THE CONTRIBUTING DRAINAGE AREA HAS BEEN

8 WHEN POSSIBLE: PRESERVE EXISTING VEGETATION (ESPECIALLY

CONSTRUCTION ACTIVITY ON SLOPES OF 20% OR MORE, MINIMIZE

9 REFER TO THE WDNR TECHNICAL STANDARDS FOR STORM WATER

ENTRANCE(S) PRIOR TO ANY LAND-DISTURBING ACTIVITIES, INCLUDING

CLEARING AND GRUBBING. USE WDNR TECHNICAL STANDARD STONE

TRACKING PAD AND TIRE WASHING #1057 FOR ROCK CONSTRUCTION

1 INSTALL INLET PROTECTION PRIOR TO LAND-DISTURBING ACTIVITIES IN

INSTALLATION. COMPLY WITH WDNR TECHNICAL STANDARD STORM

CUMMULATIVE EXPOSED AREA. CONDUCT ROUGH GRADING PER

WDNR TECHNICAL STANDARD TEMPORARY GRADING PRACTICES FOR

SCHEDULED TO OCCUR IN AREAS OF SOIL AND/OR GROUNDWATER

CONTAMINATION, OR IF DEWATERING WILL OCCUR FROM A HIGH

CAPACITY WELL (70 GPM OR MORE). DEWATER ONLY AFTER THE

APPROPRIATE WONR DEWATERING DISCHARGE PERMIT HAS BEEN

http://dnr.wi.gov/topic/stormwater/standards/const\_standards.html

O INSTALL PERIMETER CONTROLS AND ROCK CONSTRUCTION

THE TRIBUTARY AREA AND/OR IMMEDIATELY UPON INLET

DRAIN INLET PROTECTION FOR CONSTRUCTION SITES #1060.

12 STAGE CONSTRUCTION GRADING ACTIVITIES TO MINIMIZE THE

3 NOTIFY AUTHORITY HAVING JURISDICTION IF DEWATERING IS

ADJACENT TO SURFACE WATERS), MINIMIZE LAND-DISTURBING

NOTE: THE DNR CONSTRUCTION SITE INSPECTION REPORT FORM CAN

HTTP://DNR.WI.GOV/RUNOFF/PDF/STORMWATER/3400187\_CONSTRUCTI

A DESCRIPTION OF ANY EROSION AND SEDIMENT CONTROL

BE USED FOR THESE INSPECTIONS, WHICH IS LOCATED AT:

INSPECT AND MAINTAIN ALL INSTALLED EROSION CONTROL

LEAST ONCE EVERY 7 DAYS AND WITHIN 24 HOURS AFTER A

4 SUBMIT PLAN REVISIONS OR AMENDMENTS TO THE WDNR.

THE DNR WHEN ALL LAND DISTURBING ACTIVITIES HAVE CEASED, ALL

LAND DISTURBANCE AND MAINTAIN UNTIL CONSTRUCTION ACTIVITIES

This project is anticipated to disturb approximately 3.82 Acres.

HAVE CEASED, THE SITE IS STABILIZED, AND A NOTICE OF

TERMINATION IS FILED WITH WDNR.

THROUGHOUT THE DURATION OF THE PROJECT.

a DATE, TIME ANE EXACT PLACE OF INSPECTION.

CONTROLS

CONSTRUCTION AT

ENTRANCE(S).

OBTAINED.

EROSION CONTROL #1067.


NAME(S) OF INDIVIDUAL(S) PERFORMING INSPECTION

IMPLEMENTATION AND MAINTENANCE PERFORMED.

ON\_SITE\_INSPECTION\_REPORT.PDF

SOIL COMPACTION, AND PRESERVE TOPSOIL.

Initial Downstream Receiving Water of the State from the site: Swan

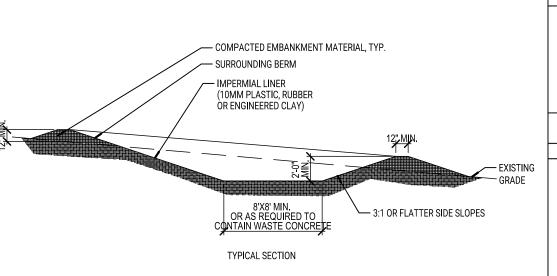

### CONCRETE WASHOUT AREA INSTALLATION NOTES

- SEE EROSION CONTROL PLAN FOR LOCATIONS OF CONCRETE WASHOUT AREA(S). TO BE PLACED A MIN. OF 50' FROM DRAINAGEWAYS, BODIES OF WATER, AND INLETS.
- THE CONCRETE WASHOUT AREA(S) SHALL BE INSTALLED PRIOR TO ANY CONCRETE PLACEMENT VEHICLE TRACKING CONTROL PAD IS REQ'D AT THE ACCESS POINT(S).
  SIGNS SHALL BE PLACED AT THE CONSTRUCTION ENTRANCE, AT THE WASHOUT AREA(S), AND
- ELSEWHERE AS NECESSARY TO CLEARLY INDICATE THE LOCATION OF THE CONCRETE WASHOUT EAS TO OPERATORS OF CONCRETE TRUCKS AND PUMP RIGS EXCAVATED MATERIAL SHALL BE UTILIZED IN PERIMETER BERM CONSTRUCTION.
- CONCRETE WASHOUT AREA MAINTENANCE NOTES
- THE CONCRETE WASHOUT AREA SHALL BE REPAIRED AND ENLARGED OR CLEANED OUT AS NECESSARY TO MAINTAIN CAPACITY FOR WASTED CONCRETE. AT THE END OF CONSTRUCTION, ALL CONCRETE SHALL BE REMOVED FROM SITE AND DISPOSED OF AT AN APPROVED WASTE SIT
- WHEN CONCRETE WASHOUT AREA(S) IS REMOVED, THE DISTURBED AREA SHALL BE STABILIZED PER SITE EROSION CONTROL MEASURES. INSPECT WEEKLY AND DURING AND AFTER ALL STORM EVENTS. CLEAN-OUT OR COVER WASHOUT AREA PRIOR TO PREDICTED STORM EVENTS TO PREVENT OVER-FLOW.

### CONCRETE WASHOUT AREA

SCALE: NOT TO SCALE

C802

14 DEWATERING OPERATIONS SHALL PROTECT ADJOINING PROPERTIES AND DISCHARGE LOCATIONS FROM EROSION AND PREVENT CONTAMINATION OR DEGRADATION OF QUALITY FOR GROUND AND SURFACE WATERS. ALL OPERATIONS SHALL IN ACCORDANCE WITH THE BEST MANAGEMENT PRACTICES PLAN THAT HAS BEEN DEVELOPED AND APPROVED FOR THIS SITE, WISCONSIN DEPARTMENT OF NATURAL RESOURCES CONSERVATION SEDIMENT CONTROL PRACTICE STANDARD, DE-WATERING, No. 1061, AND SHALL COMPLY WITH THE REQUIREMENTS OF THE WISCONSIN POLLUTANT DISCHARGE ELIMINATION SYSTEM (WPDES) GENERAL PERMIT NO. WI-0049344-05-0.

15 PROVIDE ANTI-SCOUR PROTECTION AND MAINTAIN NON-EROSIVE FLOW DURING DEWATERING. LIMIT PUMPING RATES TO EITHER (A) THE SEDIMENT BASIN/TRAP DESIGN DISCHARGE RATE, OR (B) THE BASIN DESIGN RELEASE RATE WITH THE CORRECTLY-FITTED HOSE AND GEOTEXTILE FILTER BAG. PERFORM DEWATERING OF ACCUMULATED SURFACE RUNOFF IN ACCORDANCE WITH WDNR TECHNICAL STANDARD DE-WATERING #1061.

COMPLETE AND STABILIZE SEDIMENT BASINS/TRAPS PRIOR TO MASS LAND DISTURBANCE TO CONTROL RUNOFF DURING CONSTRUCTION. REMOVE SEDIMENT AS NEEDED TO MAINTAIN 3 FEET OF DEPTH TO THE OUTLET, AND PROPERLY DISPOSE OF SEDIMENT REMOVED DURING MAINTENANCE. CONSTRUCT AND MAINTAIN THE SEDIMENT BASIN PER WDNR TECHNICAL STANDARD SEDIMENT BASIN #1064

CONSTRUCT AND PROTECT THE BIOINFILTRATION BASIN AND VEGETATION FROM RUNOFF AND SEDIMENT DURING CONSTRUCTION. 8 REMOVE SEDIMENT FROM BEHIND SILT FENCES AND SEDIMENT BARRIERS BEFORE SEDIMENT REACHES A DEPTH THAT IS EQUAL TO ONE-HALF OF THE FENCE AND/OR BARRIER HEIGHT. INSTALL AND MAINTAIN SILT FENCING PER WONR TECHNICAL STANDARD SILT FENCE #1056.

19 REPAIR BREAKS AND GAPS IN SILT FENCES AND BARRIERS IMMEDIATELY. REPLACE DECOMPOSING STRAW BALES (TYPICAL BALE LIFE IS 3 MONTHS). LOCATE, INSTALL, AND MAINTAIN STRAW BALES PER WDNR TECHNICAL STANDARD DITCH CHECKS #1062. 20 INSTALL AND MAINTAIN FILTER SOCKS IN ACCORDANCE WITH WDNR TECHNICAL STANDARD INTERIM MANUFACTURED PERIMETER CONTROL AND SLOPE INTERRUPTION PRODUCTS # 1071.

21 IMMEDIATELY STABILIZE STOCKPILES AND SURROUND STOCKPILES WITH SILT FENCE OR OTHER PERIMETER CONTROL IF STOCKPILES

WILL REMAIN INACTIVE FOR 7 DAYS OR LONGER. 22 IMMEDIATELY STABILIZE ALL DISTURBED AREAS THAT WILL REMAIN INACTIVE FOR 14 DAYS OR LONGER. BETWEEN SEPTEMBER 15 AND OCTOBER 15: STABILZE WITH MULCH, TACKIFIER, AND A PERENNIAL SEED MIXED WITH WINTER WHEAT, ANNUAL OATS, OR ANNUAL RYE. OCTOBER 15 THROUGH COLD WEATHER: STABILIZE WITH A POLYMER AND DORMANT SEED MIX 23 STABILIZE AREAS OF FINAL GRADING WITHIN 7 DAYS.

24 SWEEP/CLEAN UP ALL SEDIMENT THAT MOVES OFF-SITE DUE TO CONSTRUCTION ACTIVITY OR STORM EVENTS BEFORE THE END OF THE SAME WORKDAY OR AS DIRECTED BY AUTHORITY HAVING JURISDICTION. SEPARATE SWEPT MATERIALS (SOILS AND TRASH) AND DISPOSE OF APPROPRIATELY.

25 CONTRACTOR IS RESPONSIBLE FOR CONTROLLING DUST PER WDNR TECHNICAL STANDARD DUST CONTROL ON CONSTRUCTION SITES #

26 PROPERLY DISPOSE OF ALL WASTE AND UNUSED BUILDING MATERIALS (INCLUDING GARBAGE, DEBRIS, CLEANING WASTES, OR OTHER CONSTRUCTION MATERIALS) AND DO NOT ALLOW THESE MATERIALS TO BE CARRIED BY RUNOFF INTO THE RECEIVING CHANNEL.

COORDINATE WITH THE AUTHORITY HAVING JURISDICTION TO UPDATE THE LAND DISTURBANCE PERMIT TO INDICATE THE ANTICIPATED OR LIKELY DISPOSAL LOCATIONS FOR ANY EXCAVATED SOILS OR CONSTRUCTION DEBRIS THAT WILL LEAVE THE SITE. THE DEPOSITED OR STOCKPILED MATERIAL NEEDS TO INCLUDE PERIMETER SEDIMENT CONTROL MEASURES (SUCH AS SILT FENCE, HAY BALES, FILTER SOCKS, OR COMPACTED EARTHEN BERMS).

30 INSTALL ADDITIONAL EROSION AND SEDIMENT CONTROL MEASURES AS NEEDED (SUCH AS TEMPORARY SEDIMENT BASINS, DITCH CHECKS, EROSION CONTROL MATTING, SILT FENCING, FILTER SOCKS, SWALES, ETC.), OR AS DIRECTED BY AUTHORITY HAVING

31 CONTRACTOR IS RESPONSIBLE FOR COMPLYING WITH ALL APPLICABLE WONR REMEDIATION AND WASTE MANAGEMENT REQUIREMENTS FOR HANDLING AND DISPOSING OF CONTAMINATED MATERIALS. SITE-SPECIFIC INFORMATION FOR AREAS WITH KNOWN OR SUSPECTED SOIL AND/OR GROUNDWATER CONTAMINATION CAN BE FOUND ON WDNR'S BUREAU OF REMEDIATION AND

REDEVELOPMENT TRACKING SYSTEM (BRRTS) PUBLIC DATABASE AT http://dnr.wi.gov/botw/

## LATE SEASON STABILIZATION NOTES

CONSTRUCTION SITE MUST BE PERMANENTLY OR TEMPORARILY STABILIZED BY NOVEMBER 1 OF EACH YEAR. CRITERIA FOR STABILIZATION IS:

1 PERMANENT VEGETATION OPTION a SEED ALL DISTURBED AREAS WITH PERMANENT VEGETATION BY SEP. 15. WITH APPROPRIATE FOLLOW-UP TO ADDRESS EROSION AND SEDIMENTATION PROBLEMS

2 TEMPORARY VEGETATION OPTION (SEED BEFORE 10/15): ALL DISTURBED AREAS SHALL BE TEMPORARILY SEEDED WITH A TEMPORARY SEED MIX (OATS, WINTER WHEAT OR ANNUAL RYE) BY OCT. 15, WITH APPROPRIATE FOLLOW-UP TO ADDRESS EROSION AND SEDIMENTATION PROBLEMS. THEN, PERMANENT SEED MIX SHALL BE APPLIED BY JUNE 1 OF THE FOLLOWING YEAR. SEEDING RATES AND MIXES SHALL CONFORM TO WI DOT ROADWAY STANDARD SECTION

b TEMPORARY STABILIZED VEGETATIVE COVER IS 70% VEGETATIVE COVERAGE DENISTY. COVERAGE MUST BE UNIFORM.


TEMPORARY STABILIZATION OPTION (SEED AFTER 10/15) APPLY TOPSOIL, SEED AND EROSION CONTROL WHERE SHOWN ON EROSION CONTROL PLAN. IF EROSION CONTROL PLAN DOES NOT CALL FOR EROSION MAT, THEN APPLY A TYPE A SOIL STABILIZER (OR HYDROMULCH) WITH DORMANT TEMPORARY SEED ANNUAL RYE FROM THE WI DOT PAL TO ALL DISTURBED AREAS OF THE SITE. SEED SHALL BE AT 80 LBS/ACRE WITH A 97% SEED PURITY. SEE WI DNR CONSERVATION PRACTICE STANDARD NO. 1059 SEEDING FOR CONSTRUCTION SITE EROSION CONTROL. PROVIDE 2% LOOSE SOIL FOR SEED BED.

b TEMPORARY STABILIZATION IS CONSIDERED COMPLIANT IF IT HAS SITE COVERAGE OF TOPSOIL, SEED AND TYPE A SOIL STABILIZER; AND/OR EROSION CONTROL MATTING WHERE THE SITE RESTORATION PLAN CALLS FOR EROSION CONTROL MATTING; AND/OR RIP RAP AS SHOWN ON PLANS; AND/OR FUTURE ROAD SURFACES GRADED WITH STONE BASE; AND/OR DITCHES WITH DITCH CHECKS AS SHOWN ON

#### 3 TEMPORARY STABILIZATION OPTION (UNABLE TO RE-APPLY TOPSOIL AFTER 11/1):

APPLY A TYPE A SOIL STABILIZER FROM THE WI DOT PAL TO ALL DISTURBED AREAS. INSTALL DITCH CHECKS IN ALL DITCHES WITH SLOPE GREATER THAN 0.5% AT INTERVALS WHERE THE TOP FO THE DOWNHILL DITCH CHECK IS AT THE ELEVATION OF THE FOOT OF THE JPHILL DITCH CHECK. (TRIANGULAR SILT DIKE, STONE INSTALLED PER WDNR TECH STANDARD, SEDIMENT LOG OR COMPARABLE PRODUCT APPROVED BY AUTHORITY HAVING JURISDICTION)

DISTURBED AREAS EXCLUDE ROADS AND PARKING AREAS THAT HAVE BEEN GRADED WITH BASE COURSE INSTALLED, AS WELL AS THE IMMEDIATE VICINITY (I.E. 30') OF BUILDINGS THAT ARE ACTIVELY JNDER CONSTRUCTION WHERE EXTERIOR WORK IS STILL GOING ON, AND HAVE EFFECTIVE TEMPORARY BMPs TO CONTROL SEDIMENT.

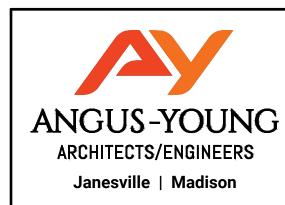

**ROCK COUNTY** 

ORFORDVILLE SALT

734 W. BELOIT STREET ORFORDVILLE, WI 53576



**ISSUANCES / REVISIONS** NO: DESCRIPTION: DATE: )1 VILLAGE SITE PLAN SUBMITTAL 09.23.202 VILLAGE SITE PLAN SUBMITTAL 01.13.2023 3 FOR BIDDING 02.01.2023 Due to electronic distribution, this drawing

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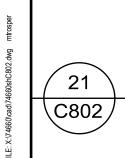
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> PROJECT NUMBER 74660 APPROVED BY BTW

> > REVIEWED BY

DRAWN BY MWT

**EROSION CONTROL NOTES AND DETAILS** 



NCHOR STAKE MIN. 18" LONG

SOIL FOR ANCHORAGE

WHEN REQUIRED BY THE ARCHITECT

TNON-WOVEN GEOTEXTILE FABRIC

(SHOWN HERE)

REINFORCED WITH SUPPORT NETTING

OVERLAND FLOW SILT FENCE DETAILS

TRENCH AND TIE BACK DETAIL

NOTE: EITHER FABRI

(SHOWN HERE)

POST PLACEMENT ALTERNATE "A"

FENCE POSTS, 4'-0" MINIMUM LENGTH WITH

2'-0" MINIMUM EMBEDMENT IN GROUND

ATTACH THE FABRIC TO THE POSTS WITH

1/2" STAPLES OR WOODEN LATH AND NAILS

TIEBACK BETWEEN FENCE

POST AND ANCHOR

IS ACCEPTABLE

WOVEN GEOTEXTILE FABRIC

WITHOUT SUPPORT NETTING


SCALE: NOT TO SCALE

ARCHITECTS/ENGINEERS



**DATE:** 02/01/202



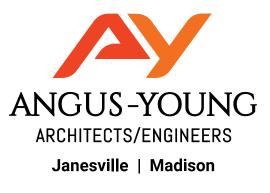

ROCK COUNTY PUBLIC WORKS

ORFORDVILLE SALT

734 WEST BELOIT ST. ORFORDVILLE, WI



ISSUANCES / REVISIONS

NO: DESCRIPTION: DATE:
BD BID/CONSTRUCTION 02/01/2023

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PROJECT NUMBER 74660

APPROVED BY

JJS

REVIEWED BY BTW

CTC
BUILDING SECTION VIEW

DRAWN BY

**1602** 

ANGUS-YOUNG ARCHITECTS/ENGINEERS Janesville | Madison

> **ROCK COUNTY** PUBLIC WORKS

ORFORDVILLE SALT

ORFORDVILLE, WI



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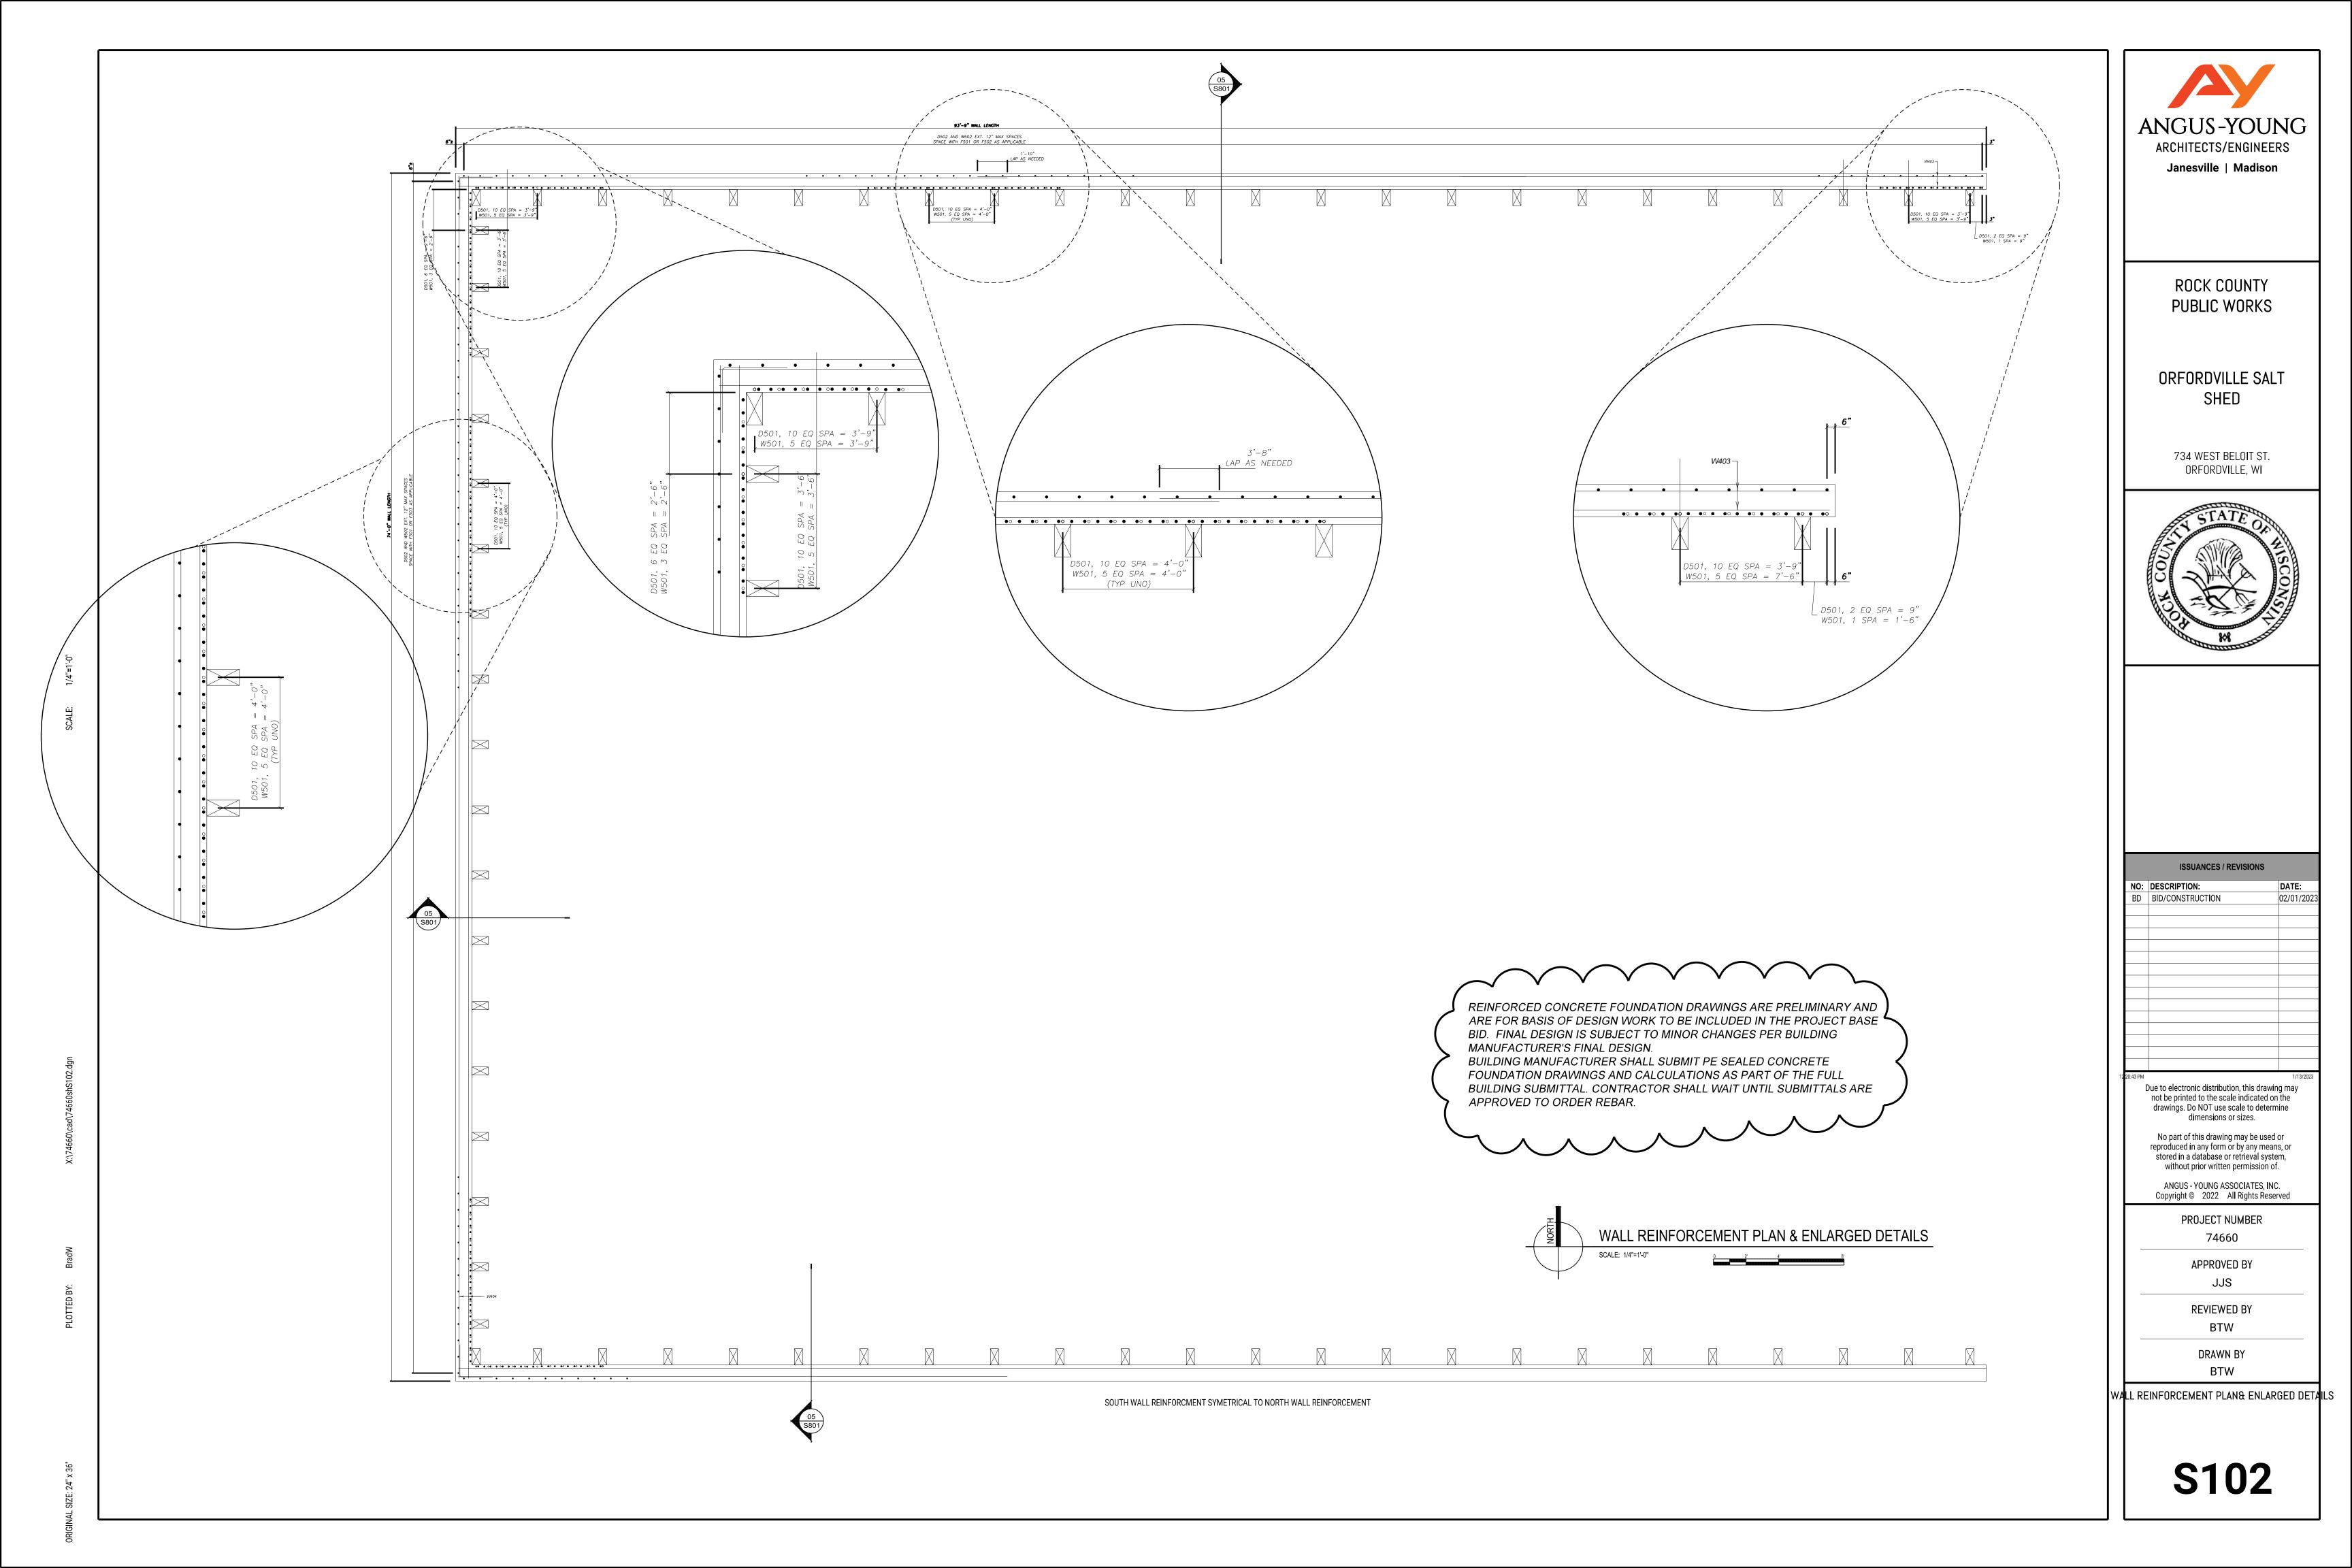
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PROJECT NUMBER

STRUCTURAL FOUNDATION PLANS



ARCHITECTS/ENGINEERS Janesville | Madison

> **ROCK COUNTY** PUBLIC WORKS

ORFORDVILLE SALT SHED

> 734 WEST BELOIT ST. ORFORDVILLE, WI



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> PROJECT NUMBER 74660

APPROVED BY

JJS

STRUCTURAL DETAILS

SMF

CALLOUT	SYMBOL	LAMP	DESCRIPTION	BALLAST / DRIVER	MOUNTING	MODEL	INPUT WATTS	VOLTS	NOTE 1	NOTE 2	NOTE 3
A1	0	(1) LED, 5000K	SURFACE 2' X 4'	LED DRIVER	SURFACE	METALUX VT4LED-LD5-24-UNV-L850-CD-1-WL-MS-U OR EQUAL	179	120V 1P 2W	MOUNT TO BOTTOM OF STRUCTURE.	PROVIDE FIXTURE MOUNTED OCCUPANCY SENSOR SUITABLE FOR EXTREME CONDITIONS.	
A1/EM	0	(1) LED, 5000K	SURFACE 2' X 4'	LED DRIVER	SURFACE	METALUX VT4LED-LD5-24-UNV-L850-EL10W-CD-1-WL-M OR EQUAL	179 S-U	120V 1P 2W	MOUNT TO BOTTOM OF STRUCTURE.	PROVIDE FIXTURE MOUNTED OCCUPANCY SENSOR SUITABLE FOR EXTREME CONDITIONS.	PROVIDE WITH 10W BATTERY BACKUP OPTION.
OA	æ	(1) LED, 5000K	WALL MOUNT	LED DRIVER	WALL	MCGRAW-EDISON GWC-SA1-C-750-U-T4FT OR EQUAL	59	120V 1P 2W	MOUNT AT 17'-0" TO BOTTOM AFF UNLESS NOTED OTHERWISE.	CONTROL VIA EXTERIOR PHOTOCELL.	
OA/EM	ø	(1) LED, 5000K	WALL MOUNT	LED DRIVER	WALL	MCGRAW-EDISON GWC-SA1-C-750-U-T4FT-CBP OR EQUAL	59	120V 1P 2W	MOUNT AT 17'-0" TO BOTTOM AFF UNLESS NOTED OTHERWISE.	CONTROL VIA EXTERIOR PHOTOCELL.	PROVIDE WITH BATTERY BACKUP.
Х	波	(1) LED	EXIT SIGN	LED	SURFACE	SURE-LITES UX7-1 OR EQUAL	1.4	120V 1P 2W	EC TO PROVIDE WITH BATTERY BACKUP OPTION.	MOUNT AT 8'-0" TO BOTTOM OF FIXTURE AFG.	


## **EQUIPMENT SCHEDULE**


CALLOUT	SYMBOL	DESCRIPTION	LOCATION	VOLTS	AMPS	KVA	HP	CIRCUIT	NOTE 1	NOTE 2	NOTE 3	DISCONNECT
OHD-1	<b>⊕</b>	OVERHEAD DOOR OPERATOR	SALT SHED	208V 3P 4W	4.85	1.75	1 HP	P1-8,10,12	PROVIDE WITH NON-FUSIBLE DISCONNECT SWITCH AT UNIT.			NON-FUSED

RO	ОМ				VOLTS 208	Y/1:	20V 3	P 4W		AIC 2	2,000	
МС	UNTING	SURFAC	E		BUS AMPS	60	)			MAIN E	BKR 60	
FEI	D FROM	А3			NEUTRAL	100	%			LUGS	STANDARD	
NO	TE NEM	IA 3R RAT	ED									
СКТ	CKT	LOAD					СКТ	СКТ	LOAE	)		
#	BKR	KVA	CIRCUIT D	ESCRIPT	ION		#	BKR	KVA	CIRCUIT	ESCRIPTION	
1	20/1	1.43	LIGHTING			а	2	20/1	0.54	RECEPTAG	CLE	
3	20/1	0.295	LIGHTING			b	4	<b>-</b> /1	0	SPACE		
5	20/1	1.43	LIGHTING			С	6	20/1	0	SPARE		
7	<b>-</b> /1	0	SPACE			а	8	20/3	1.75	OHD-1		
9	<b>-</b> /1	0	SPACE			b	10					
11	<b>-</b> /1	0	SPACE			С	12					
13	<b>-</b> /1	0	SPACE			а	14	<b>-</b> /1	0	SPACE		
15	<del>-</del> /1	0	SPACE			b	16	<b>-</b> /1	0	SPACE		
17	<b>-</b> /1	0	SPACE			С	18	-/1	0	SPACE		
		C	ONN. KVA	CALC. K	(VA					CONN. KVA	CALC. KVA	
LIG	HTING	3	.16	3.95	(125%)	(	CONT	INUOUS		0	0	(125%
LAF	RGEST M	OTOR 1	.75	2.18	(125%)	ŀ	HEAT	ING		0	0	(100%
OTH	HER MOT	ORS 0	1	0	(100%)	1	NON	CONTINU	ous	0	0	(100%
RE	CEPTACL	.ES 0	.54	0.54	(50%>10)	ŀ	KITCH	HEN EQU	IP	0	0	(N/A)

NONCOIN/DIVERSE TOTAL KVA

BALANCED THREE PHASE AMPS 18.5

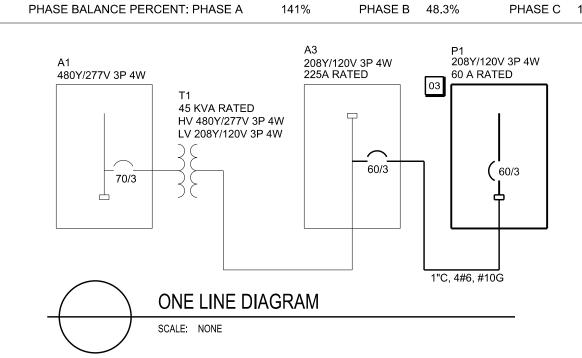

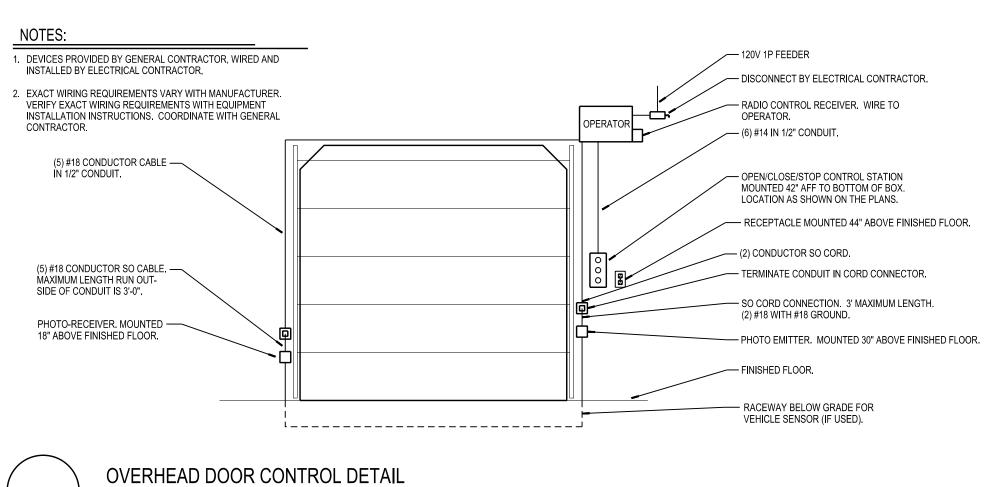

SCALE: NONE

#### NEW RECEPTACLE SCHEDULE SYMBOL NEMA VOLTS NOTE 1 NOTE 2 NOTE 3 CALLOUT **FEATURES** WEATHERPROOF MOUNT @ 24" TO BOTTOM PROVIDE WITH IN-USE WEATHER 5-20R | 120V 1P 2W UNLESS NOTED OTHERWISE PROOF COVER GFCI DUPLEX

NEW SWITCH SCHEDULE								
CALLOUT	SYMBOL	NOTE 1	NOTE 2	NOTE 3				
1 POLE SWITCH	\$	MOUNT AT 44" TO BOTTOM UNLESS NOTED OTHERWISE						
EXTERIOR PHOTOCELL - LINE VOLTAGE	<b>©</b> 1	LOCATE HIGH ON WALL ON NORTH WALL OR WHERE SHOWN ON FLOORPLAN	ACCEPTABLE MODELS: INTERMATIC K4221C, TORK 2001, PRECISION ST-15					

GENERAL NOTES

- THE BUILDING WILL REMAIN OCCUPIED AND IN USE DURING THE RENOVATION PROCESS. SCHEDULE THE WORK TO MINIMIZE DISRUPTION AND COORDINATE ANY NECESSARY DISRUPTIONS WITH THE OWNER.
- THE INFORMATION SHOWN ON THESE DRAWINGS WAS OBTAINED FROM THE ORIGINAL CONSTRUCTION DRAWINGS WHERE AVAILABLE, AND FROM LIMITED FIELD REVIEW OF THE BUILDING AND SYSTEMS, PRIOR TO BIDDING, EACH CONTRACTOR SHALL INVESTIGATE THE EXISTING SYSTEM TO THE EXTENT NECESSARY TO ACCURATELY DETERMINE THE EXACT EXTENT OF THE REQUIRED WORK
- 3. THE CONTRACTOR'S BID PRICE SHALL INCLUDE THE RESOLUTION OF MINOR DISCREPANCIES AT NO COST TO THE OWNER. PRIOR TO THE START OF THE RENOVATION THE CONTRACTOR SHALL RE-VERIFY ALL EXISTING ELECTRICAL SYSTEMS AND SYSTEM COMPONENTS AND REPORT ANY SIGNIFICANT DISCREPANCIES FOUND TO THE A/E FOR RESOLUTION. ANY

CONTROLLED EQUIPMENT OR COMPONENTS NOT NOTED IN THE PLANS OR SPECS BUT FOUND PRIOR TO OR DURING COMPLETION OF THE NEW WORK SHALL ALSO BE REPORTED TO THE A/E.

- 4. THE CONTRACTOR SHALL FIELD VERIFY ACTUAL LOCATION AND SIZE OF EXISTING BRANCH CIRCUIT WIRING, PANEL CAPACITY, CONDITION, AND BREAKERS.
- CONTRACTOR SHALL PROTECT ALL WALLS, CEILINGS, FLOORS, LIGHTS AND OTHER FINISHED SURFACES. IF DAMAGED, CONTRACTOR SHALL REPAIR OR REPLACE TO MATCH EXISTING CONDITIONS AT NO ADDITIONAL COST TO THE OWNER. VERIFY LOCATIONS OF AND PROTECT EXISTING INTERIOR ELECTRICAL AND MECHANICAL UTILITIES AND SERVICES.
- ANY ELECTRICAL EQUIPMENT FOUND TO BE NON-FUCTIONAL OR IN NEED OF REPAIR OR MAINTENANCE WORK SHALL BE REPORTED TO THE A/E AND THE OWNER.
- ELECTRICAL CONTRACTOR TO CALCULATE VOLTAGE DROP OF ALL BRANCH CIRCUITS EXCEEDING 100' AND INCREASE CONDUCTOR AND GROUND SIZES AS REQUIRED TO MAINTAIN LESS THAN 5% COMBINED FEEDER/BRANCH VOLTAGE DROP AT THE FARTHEST LOAD.
- 8. EXTERIOR LIGHT FIXTURES ARE TO BE CONTROLLED BY EXTERIOR TYPE 1 PHOTOCELL.

KEYNOTES

- EC TO INSTALL NEW 18-POLE 208Y/120V 3P 4W PANEL WITH 60A MAIN. THE NEW PANEL IS TO BE FED FROM EXISTING PANEL AS LOCATED IN THE DPW BUILDING TO THE SOLITH VIA LINDERGROUND EFFED. NEW PANELBOARD IS TO BE NEMA 3R RATED FOR OUTDOOR INSTALLATION.
- 02 ELECTRICAL INSTALLATIONS ARE TO BE CORROSIVE RESISTANT.
- EXISTING PANELBOARD A3 LOCATED WITHIN EXISTING DPW BUILDING. FEED NEW PANEL P1 FROM SPARE 60A/3P BREAKER. ALL CONDUIT FEEDING EXTERIOR LIGHT FIXTURES IS TO BE ROUTED THOUGH THE BUILDING.

ARCHITECTS/ENGINEERS

Janesville | Madison

**ROCK COUNTY** 

PUBLIC WORKS

ORFORDVILLE SALT

734 WEST BELOIT ST.

ORFORDVILLE, WI

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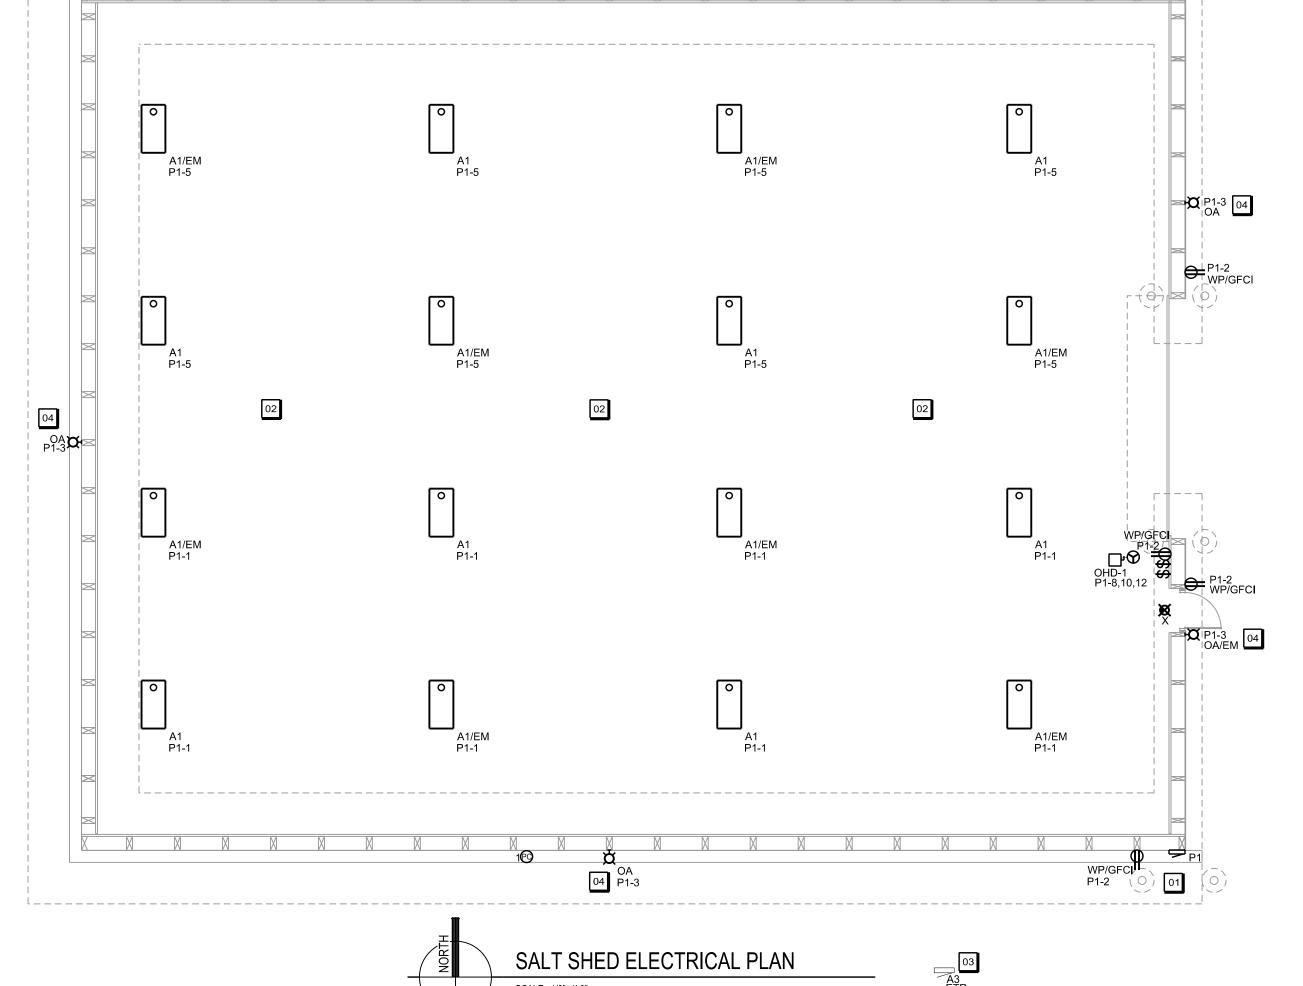
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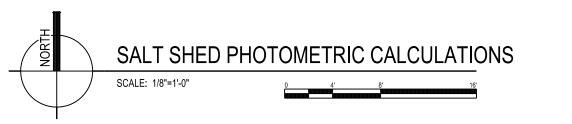
APPROVED BY

REVIEWED BY

DRAWN BY MRA

SALT SHED ELECTRICAL PLAN AND ONE LINE DIAGRAM





GENERAL NOTES

- THE BUILDING WILL REMAIN OCCUPIED AND IN USE DURING THE RENOVATION PROCESS. SCHEDULE THE WORK TO MINIMIZE DISRUPTION AND COORDINATE ANY NECESSARY DISRUPTIONS WITH THE OWNER.
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- 6. ANY ELECTRICAL EQUIPMENT FOUND TO BE NON-FUCTIONAL OR IN NEED OF REPAIR OR MAINTENANCE WORK SHALL BE REPORTED TO THE A/E AND THE OWNER.
- 7. ALL EXPOSED LOW VOLTAGE CABLING TO BE IN CONDUIT. LOW VOLTAGE CABLING ABOVE CEILING IS TO BE PLENUM RATED.
- 8. ELECTRICAL CONTRACTOR TO CALCULATE VOLTAGE DROP OF ALL BRANCH CIRCUITS EXCEEDING 100' AND INCREASE CONDUCTOR AND GROUND SIZES AS REQUIRED TO MAINTAIN LESS THAN 5% COMBINED FEEDER/BRANCH VOLTAGE DROP AT THE FARTHEST LOAD.
- 9. EXTERIOR LIGHT FIXTURES ARE TO BE CONTROLLED BY EXTERIOR TYPE 1 PHOTOCELL.



ROCK COUNTY PUBLIC WORKS

ORFORDVILLE SALT SHED

> 734 WEST BELOIT ST. ORFORDVILLE, WI



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> PROJECT NUMBER 74660

APPROVED B

APPROVED BY JJS

REVIEWED BY BTW

> DRAWN BY MRA

SALT SHED
PHOTOMETRIC CALCULATIONS

E102